




01 SCHEDULE OF DOORS & WINDOWS
1:100


		PRC: 8270	SECTION 33 of RA 9266 Drawing &	PROJECT TITLE / LOCATION	APPROVED BY	PREPARED BY:	SHEET NO.
PLANS • DESIGNS • ESTIMATES • CONSTRUCTION MANAGEMENT • DESIGNS BUILT • PLUMBING DESIGN		DATE 188. 10 SAN 2017	specifications & other contract documents duly signed, stamp or sealed, as instruments of service, are the intellectual property and documents of the architect, wether the object for which they are made is executed or not it shall be unlawful for any person to duplicate or to make copies of said documents for use in the repetition of & for other projects or buildings, whether executed partly or in whole, without the	ACADEMIC BUILDING FOR SENIOR HIGH PROGRAM	OWNER ADDRESS:	JUNIOR ARCHITECT CHECKED BY:	A- 05 05
27 P. ACHARON BOULEVARD, BRGY. DAD. SOUTH, GEN. SANTOS CITY Solution 27 P. ACHARON BOULEVARD, BRGY. DAD. SOUTH, GEN. SANTOS CITY Solution 27 P. ACHARON BOULEVARD, BRGY. DAD. SOUTH, GEN. SANTOS CITY Solution 27 P. ACHARON BOULEVARD, BRGY. DAD. SOUTH, GEN. SANTOS CITY Solution 27 P. ACHARON BOULEVARD, BRGY. DAD. SOUTH, GEN. SANTOS CITY Solution 27 P. ACHARON BOULEVARD, BRGY. DAD. SOUTH, GEN. SANTOS CITY Solution 27 P. ACHARON BOULEVARD, BRGY. DAD. SOUTH, GEN. SANTOS CITY Solution 27 P. ACHARON BOULEVARD, BRGY. DAD. SOUTH, GEN. SANTOS CITY Solution 27 P. ACHARON BOULEVARD, BRGY. DAD. SOUTH, GEN. SANTOS CITY Solution 27 P. ACHARON BOULEVARD, BRGY. DAD. SOUTH, GEN. SANTOS CITY Solution 27 P. ACHARON BOULEVARD, BRGY. DAD. SOUTH, GEN. SANTOS CITY Solution 27 P. ACHARON BOULEVARD, BRGY. DAD. SOUTH, GEN. SANTOS CITY Solution 27 P. ACHARON BOULEVARD, BRGY. DAD. SOUTH, GEN. SANTOS CITY Solution 27 P. ACHARON BOULEVARD, BRGY. DAD. SOUTH, GEN. SANTOS CITY Solution 27 P. ACHARON BOULEVARD, BRGY. DAD. SOUTH, GEN. SANTOS CITY Solution 27 P. ACHARON BOULEVARD, BRGY. DAD. SOUTH, GEN. SANTOS CITY Solution 27 P. ACHARON BOULEVARD, BRGY. DAD. SOUTH, GEN. SANTOS CITY Solution 27 P. ACHARON BOULEVARD, BRGY. DAD. SOUTH, GEN. SANTOS CITY Solution 27 P. ACHARON BOULEVARD, BRGY. DAD. SOUTH, GEN. SANTOS CITY Solution 27 P. ACHARON BOULEVARD, BRGY. DAD. SOUTH, GEN. SANTOS CITY SOLUTION BROWN BOULEVARD, BRGY. DAD. SOUTH, GEN. SANTOS CITY SOLUTION BROWN BOULEVARD, BRGY. DAD. SOUTH, GEN. SANTOS CITY SOLUTION BROWN	ARCHITECT	PLACE ISS. GSC TIN 123-875-856	written consent of architect or author of said documents.			RESIDENT ENGINEER	
						FILE NAME: ACAD4-AUGUST 21, 2017- UPDATED.dwg	August 21, 2017

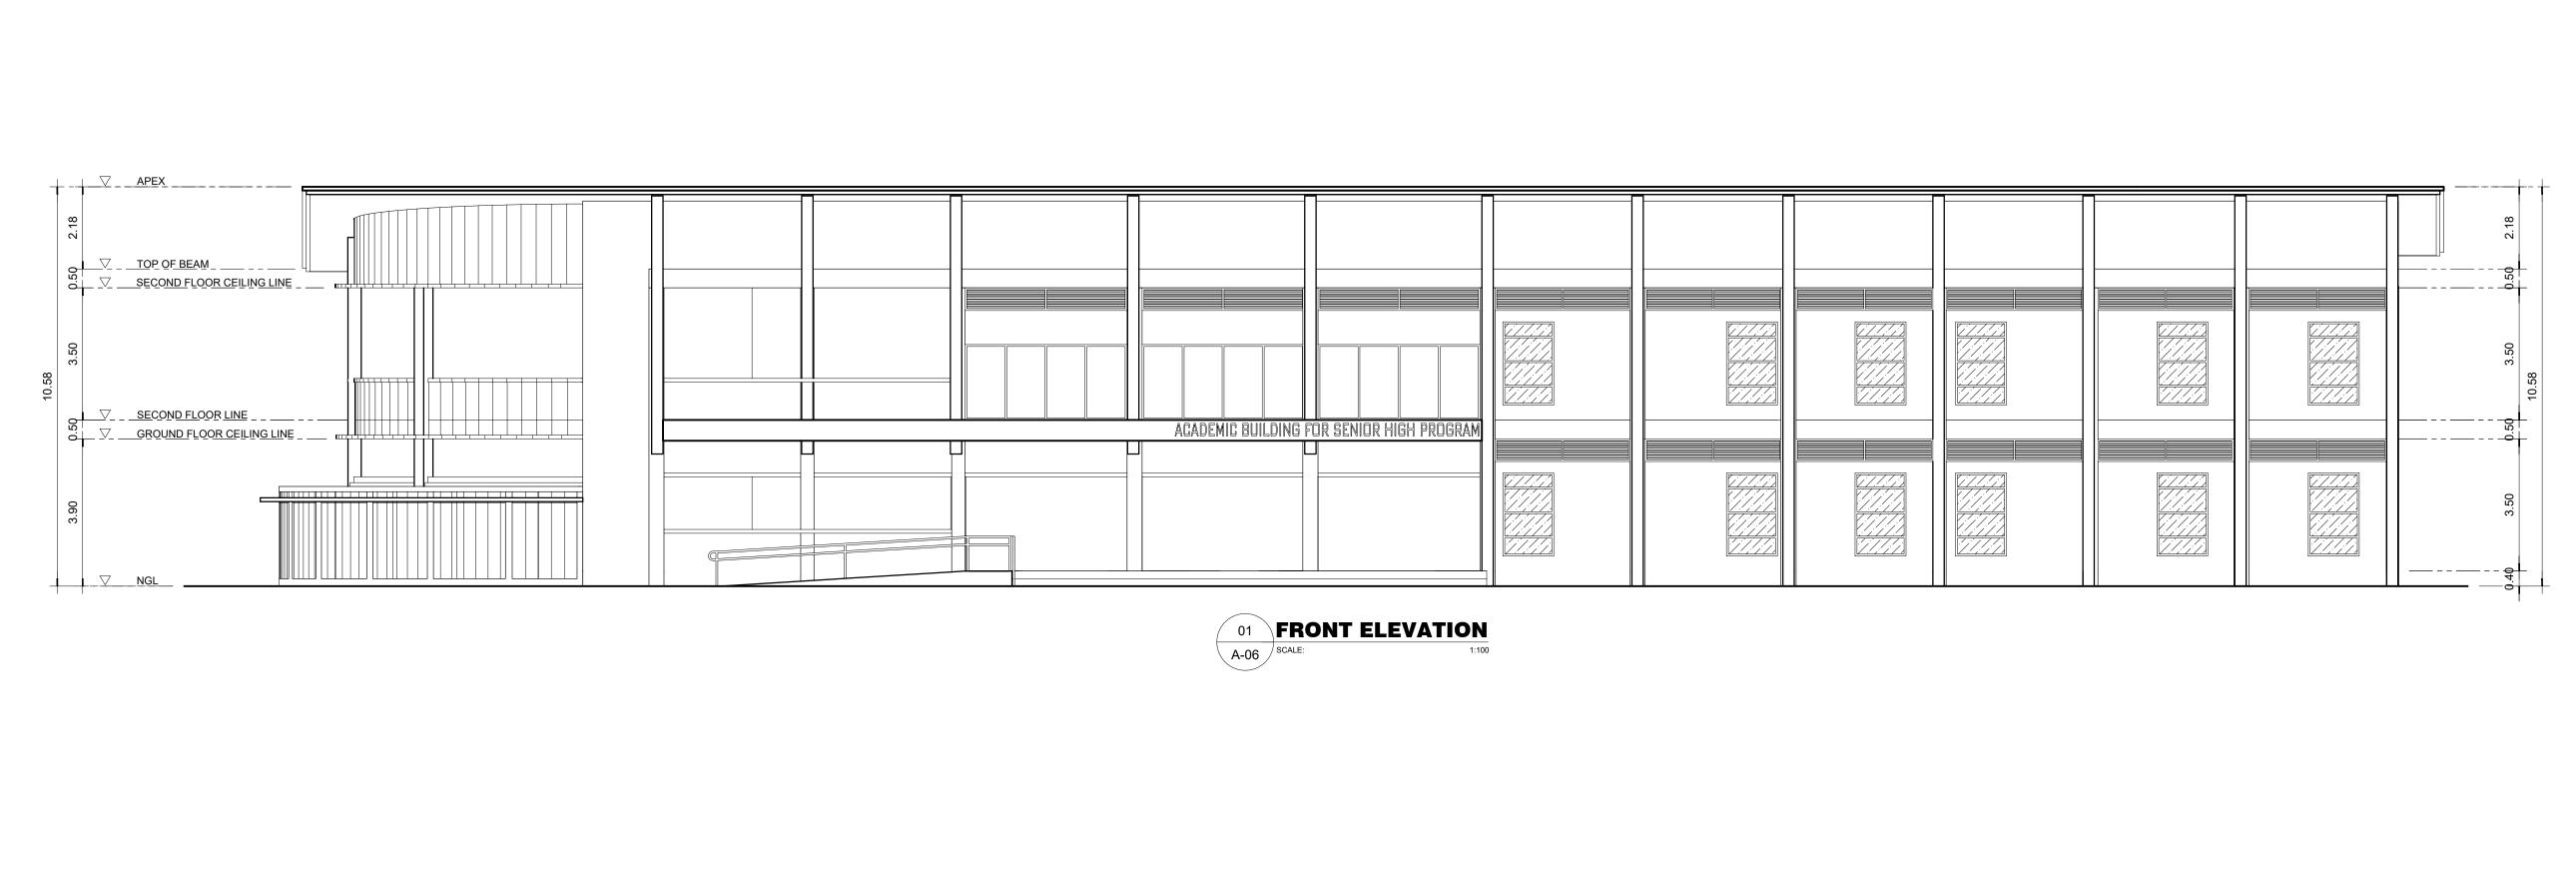

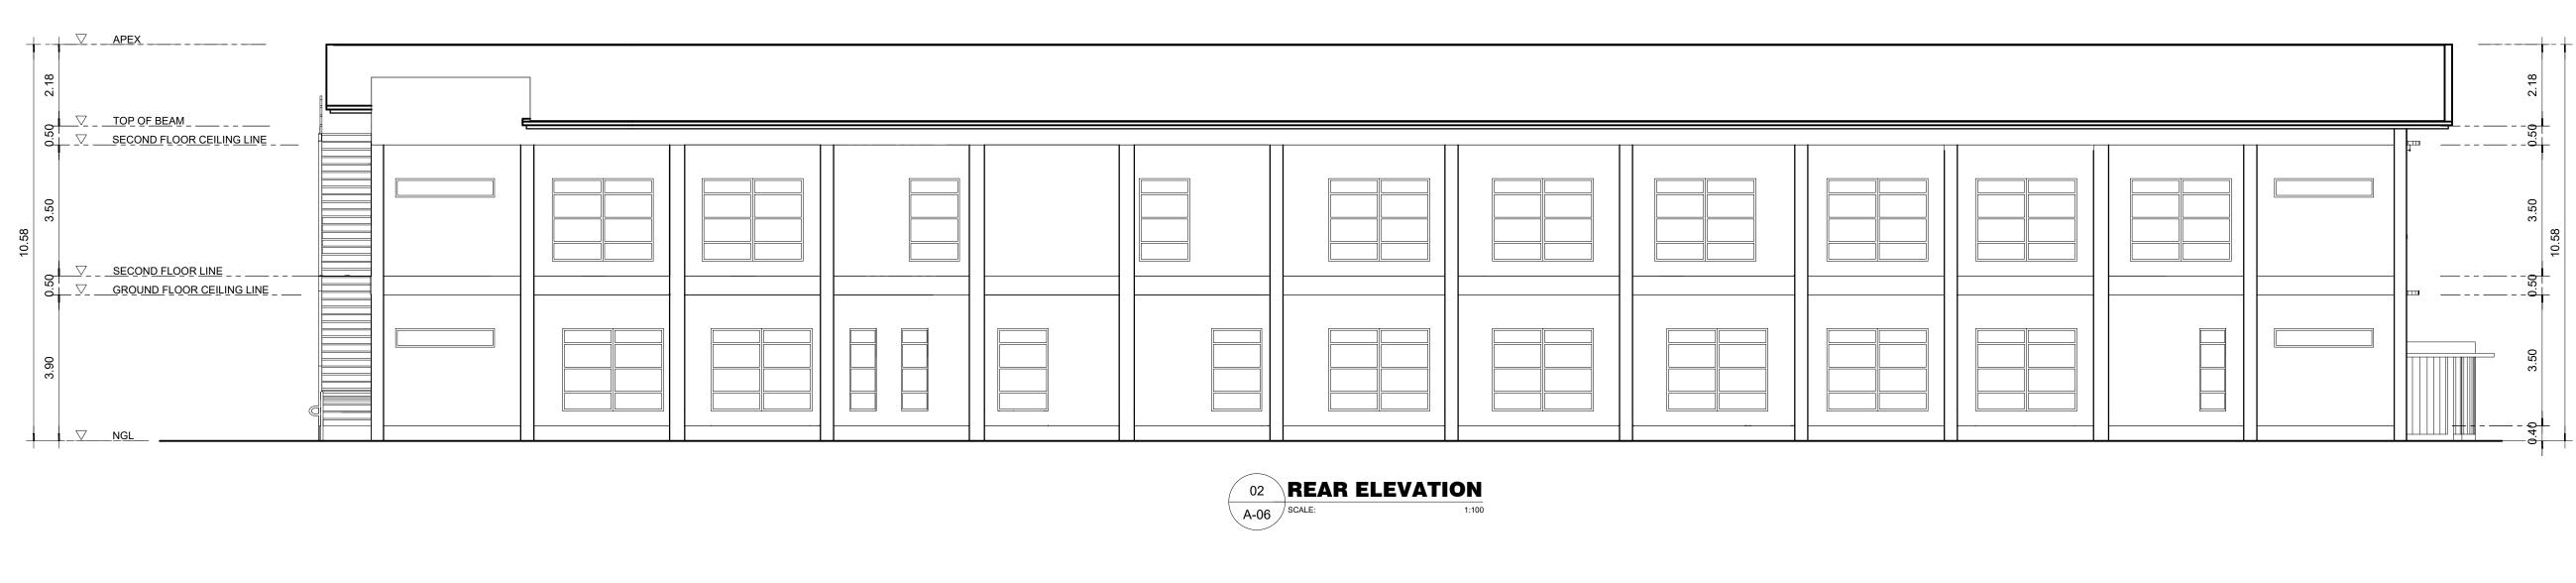



		PRC: 8270	SECTION 33 of RA 9266 Drawing & specifications & other contract documents	PROJECT TITLE / LOCATION	APPROVED BY	PREPARED BY:	SHEET NO.
M.T. Ang architectural designs		VALIDITY 08 MAY 2018 IAPOA: 04440 141342 071615 O.R. DATE 141342 16JULY15	duly signed, stamp or sealed, as instruments of service, are the intellectual property and documents of the architect, wether the object for which they are made is expected or part it shall be unlawful for	ACADEMIC BUILDING FOR SENIOR		JUNIOR ARCHITECT	A- 06
	MICHAEL T. ANG, fuap	DATE ISS. 10 JAN 2017	any person to duplicate or to make copies of said documents for use in the repetition of & for other projects or buildings, whether executed partly or in whole, without the	HIGH PROGRAM	OWNER ADDRESS:	CHECKED BY :	06
27 P. ACHARON BOULEVARD, BRGY. DAD. SOUTH, GEN. SANTOS CITY Solution 27 P. ACHARON BOULEVARD, BRGY. DAD. SOUTH, GEN. SANTOS CITY Solution 27 P. ACHARON BOULEVARD, BRGY. DAD. SOUTH, GEN. SANTOS CITY Solution 27 P. ACHARON BOULEVARD, BRGY. DAD. SOUTH, GEN. SANTOS CITY Solution 27 P. ACHARON BOULEVARD, BRGY. DAD. SOUTH, GEN. SANTOS CITY Solution 27 P. ACHARON BOULEVARD, BRGY. DAD. SOUTH, GEN. SANTOS CITY Solution 27 P. ACHARON BOULEVARD, BRGY. DAD. SOUTH, GEN. SANTOS CITY Solution 27 P. ACHARON BOULEVARD, BRGY. DAD. SOUTH, GEN. SANTOS CITY Solution 27 P. ACHARON BOULEVARD, BRGY. DAD. SOUTH, GEN. SANTOS CITY Solution 27 P. ACHARON BOULEVARD, BRGY. DAD. SOUTH, GEN. SANTOS CITY Solution 27 P. ACHARON BOULEVARD, BRGY. DAD. SOUTH, GEN. SANTOS CITY Solution 27 P. ACHARON BOULEVARD, BRGY. DAD. SOUTH, GEN. SANTOS CITY Solution 27 P. ACHARON BOULEVARD, BRGY. DAD. SOUTH, GEN. SANTOS CITY Solution 27 P. ACHARON BOULEVARD, BRGY. DAD. SOUTH, GEN. SANTOS CITY Solution 27 P. ACHARON BOULEVARD, BRGY. DAD. SOUTH,	ARCHITECT	PLACE ISS. GSC TIN 123-875-856	written consent of architect or author of said documents.			RESIDENT ENGINEER	

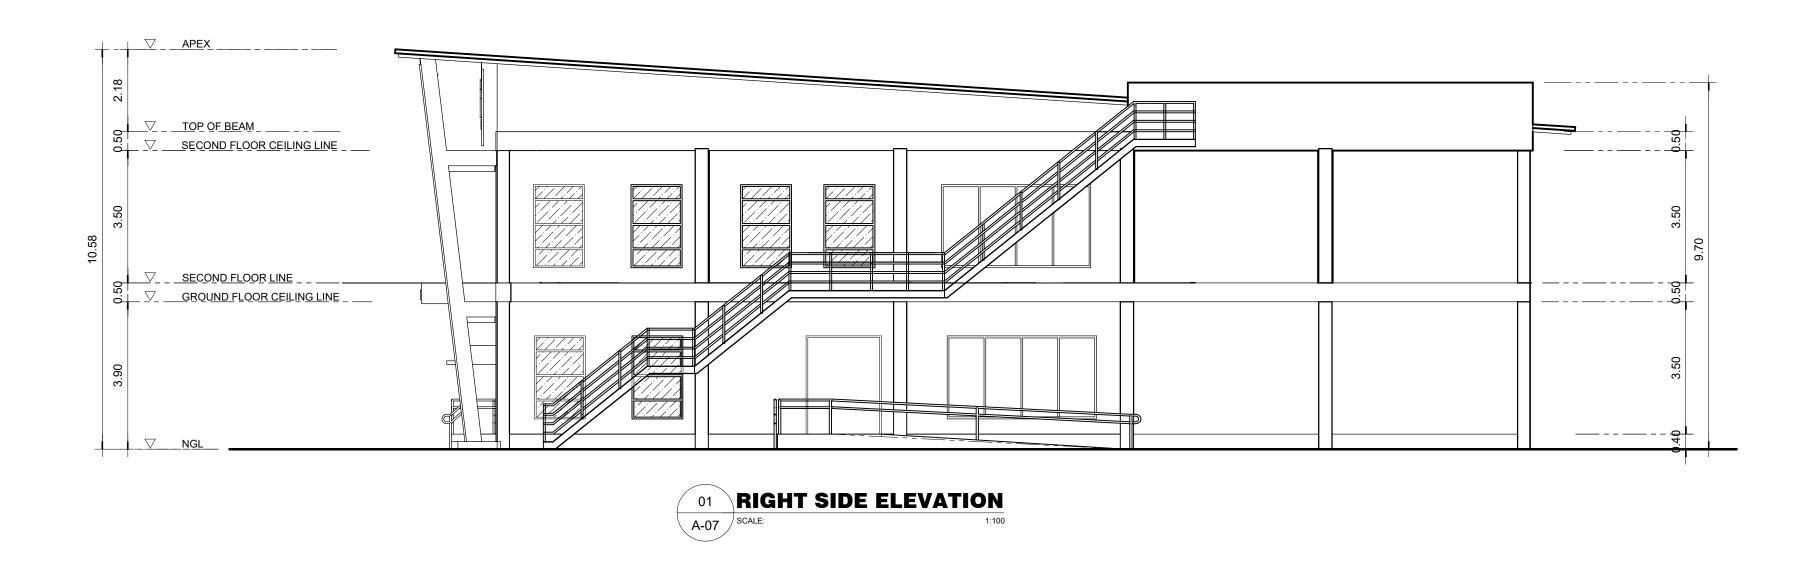


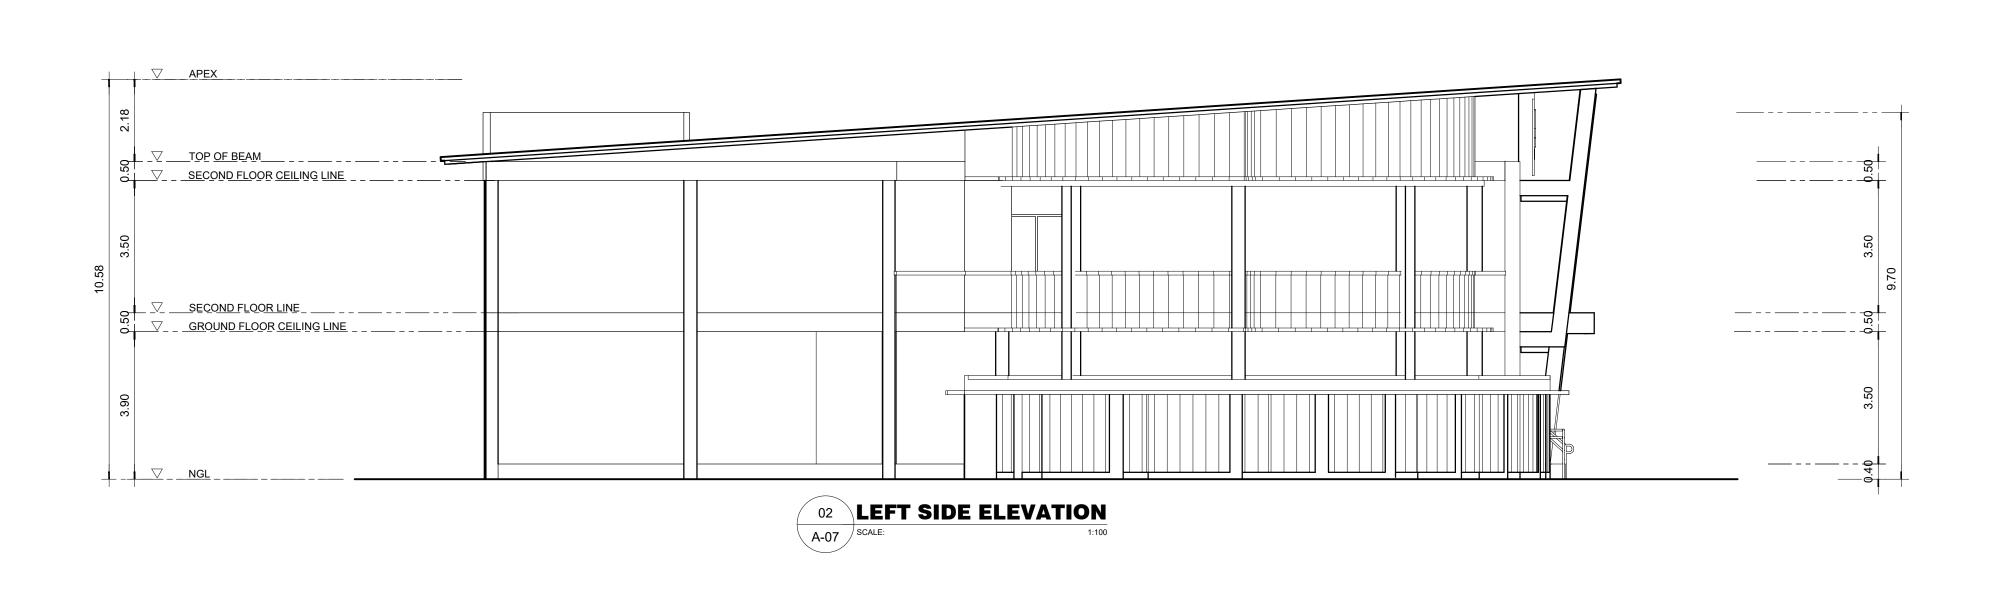



		PRC: VALIDITY	8270 08 MAY 2018	SECTION 33 of RA 9266 Drawing & specifications & other contract documents	PROJECT TITLE / LOCATION	APPROVED BY	PREPARED BY:	SHEET NO.
PLANS • DESIGNS • ESTIMATES • CONSTRUCTION MANAGEMENT • DESIGNS BUILT • PLUMBING DESIGN	MICHAEL T. ANG, fuap	IAPOA:	04440 141342 07161	duly signed, stamp of sealed, as instruments of service, are the intellectual property and documents of the architect, wether the object for which they are made is executed or not it shall be unlawful for any person to duplicate or to make copies of said documents for use in the repetition	ACADEMIC BUILDING FOR SENIOR	 OWNER	JUNIOR ARCHITECT	Δ- 07
		PTR	7193602		HIGH PROGRAM		CHECKED BY:	
	, 1	DATE ISS. PLACE ISS.	10 JAN 2017 GSC	of & for other projects or buildings, whether executed partly or in whole, without the		ADDRESS:		07
27 P. ACHARON BOULEVARD, BRGY. DAD. SOUTH, GEN. SANTOS CITY	Anomiteur	TIN	123-875-856	said documents.			RESIDENT ENGINEER	<u> </u>

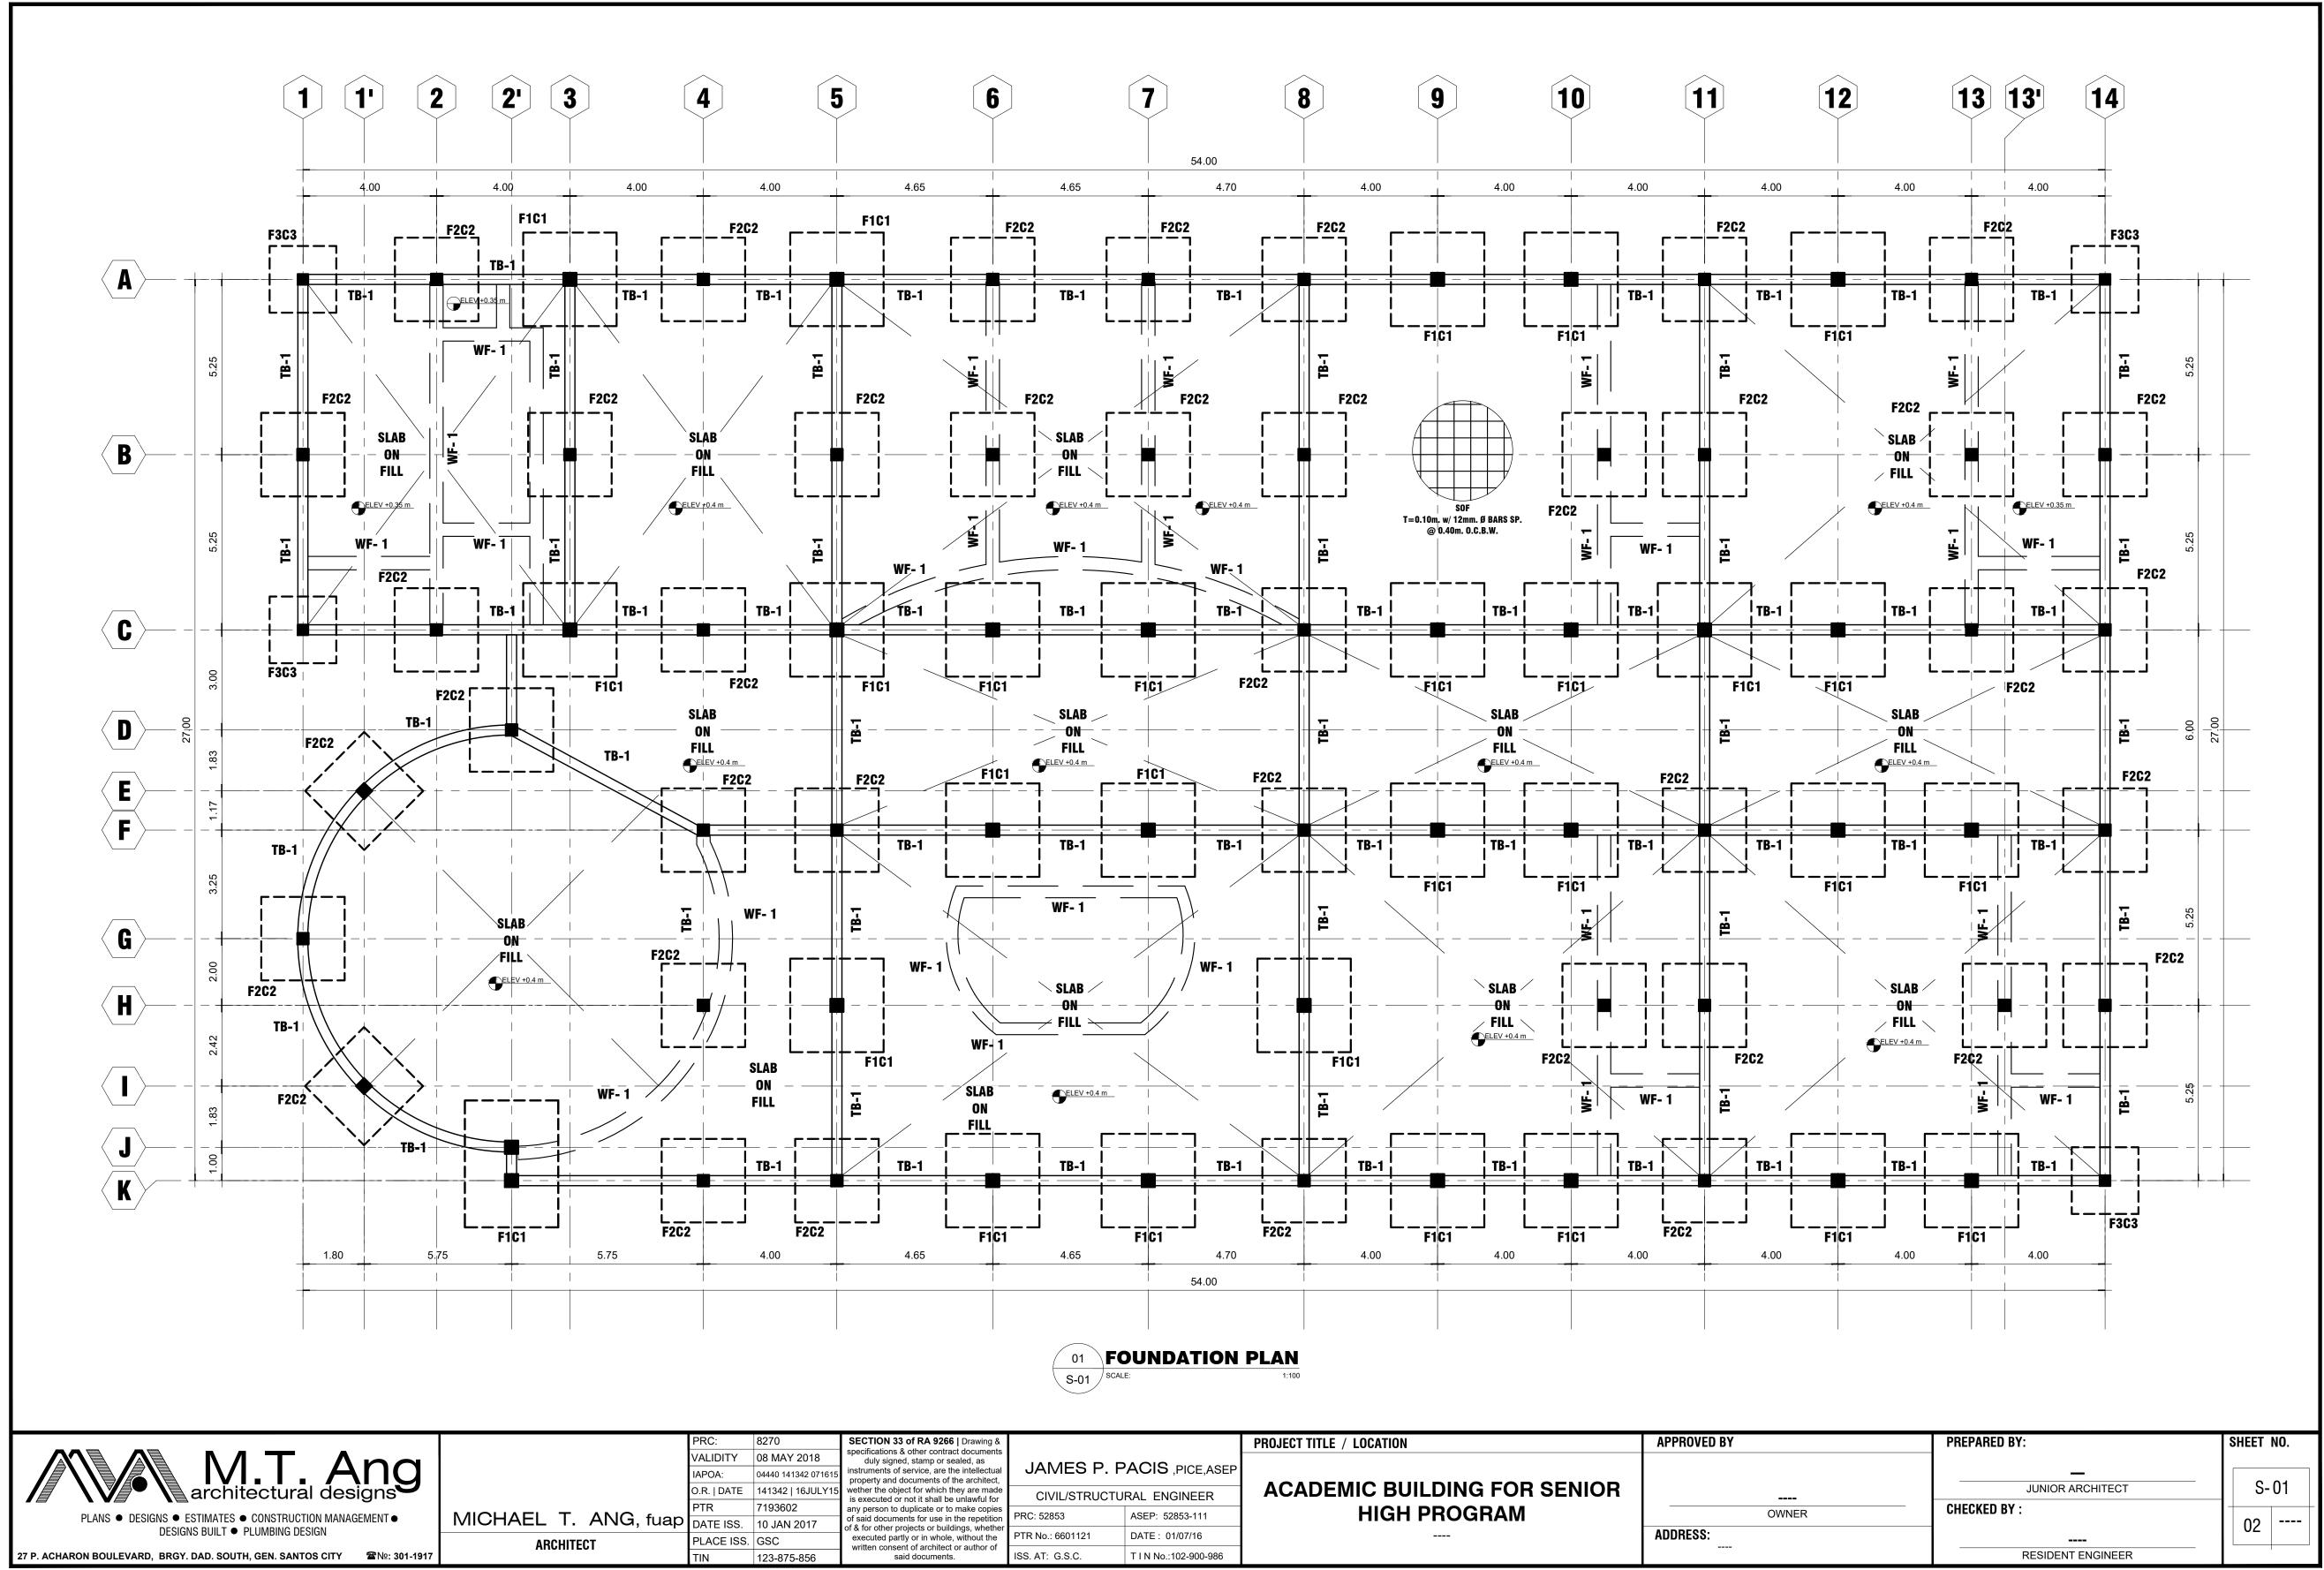


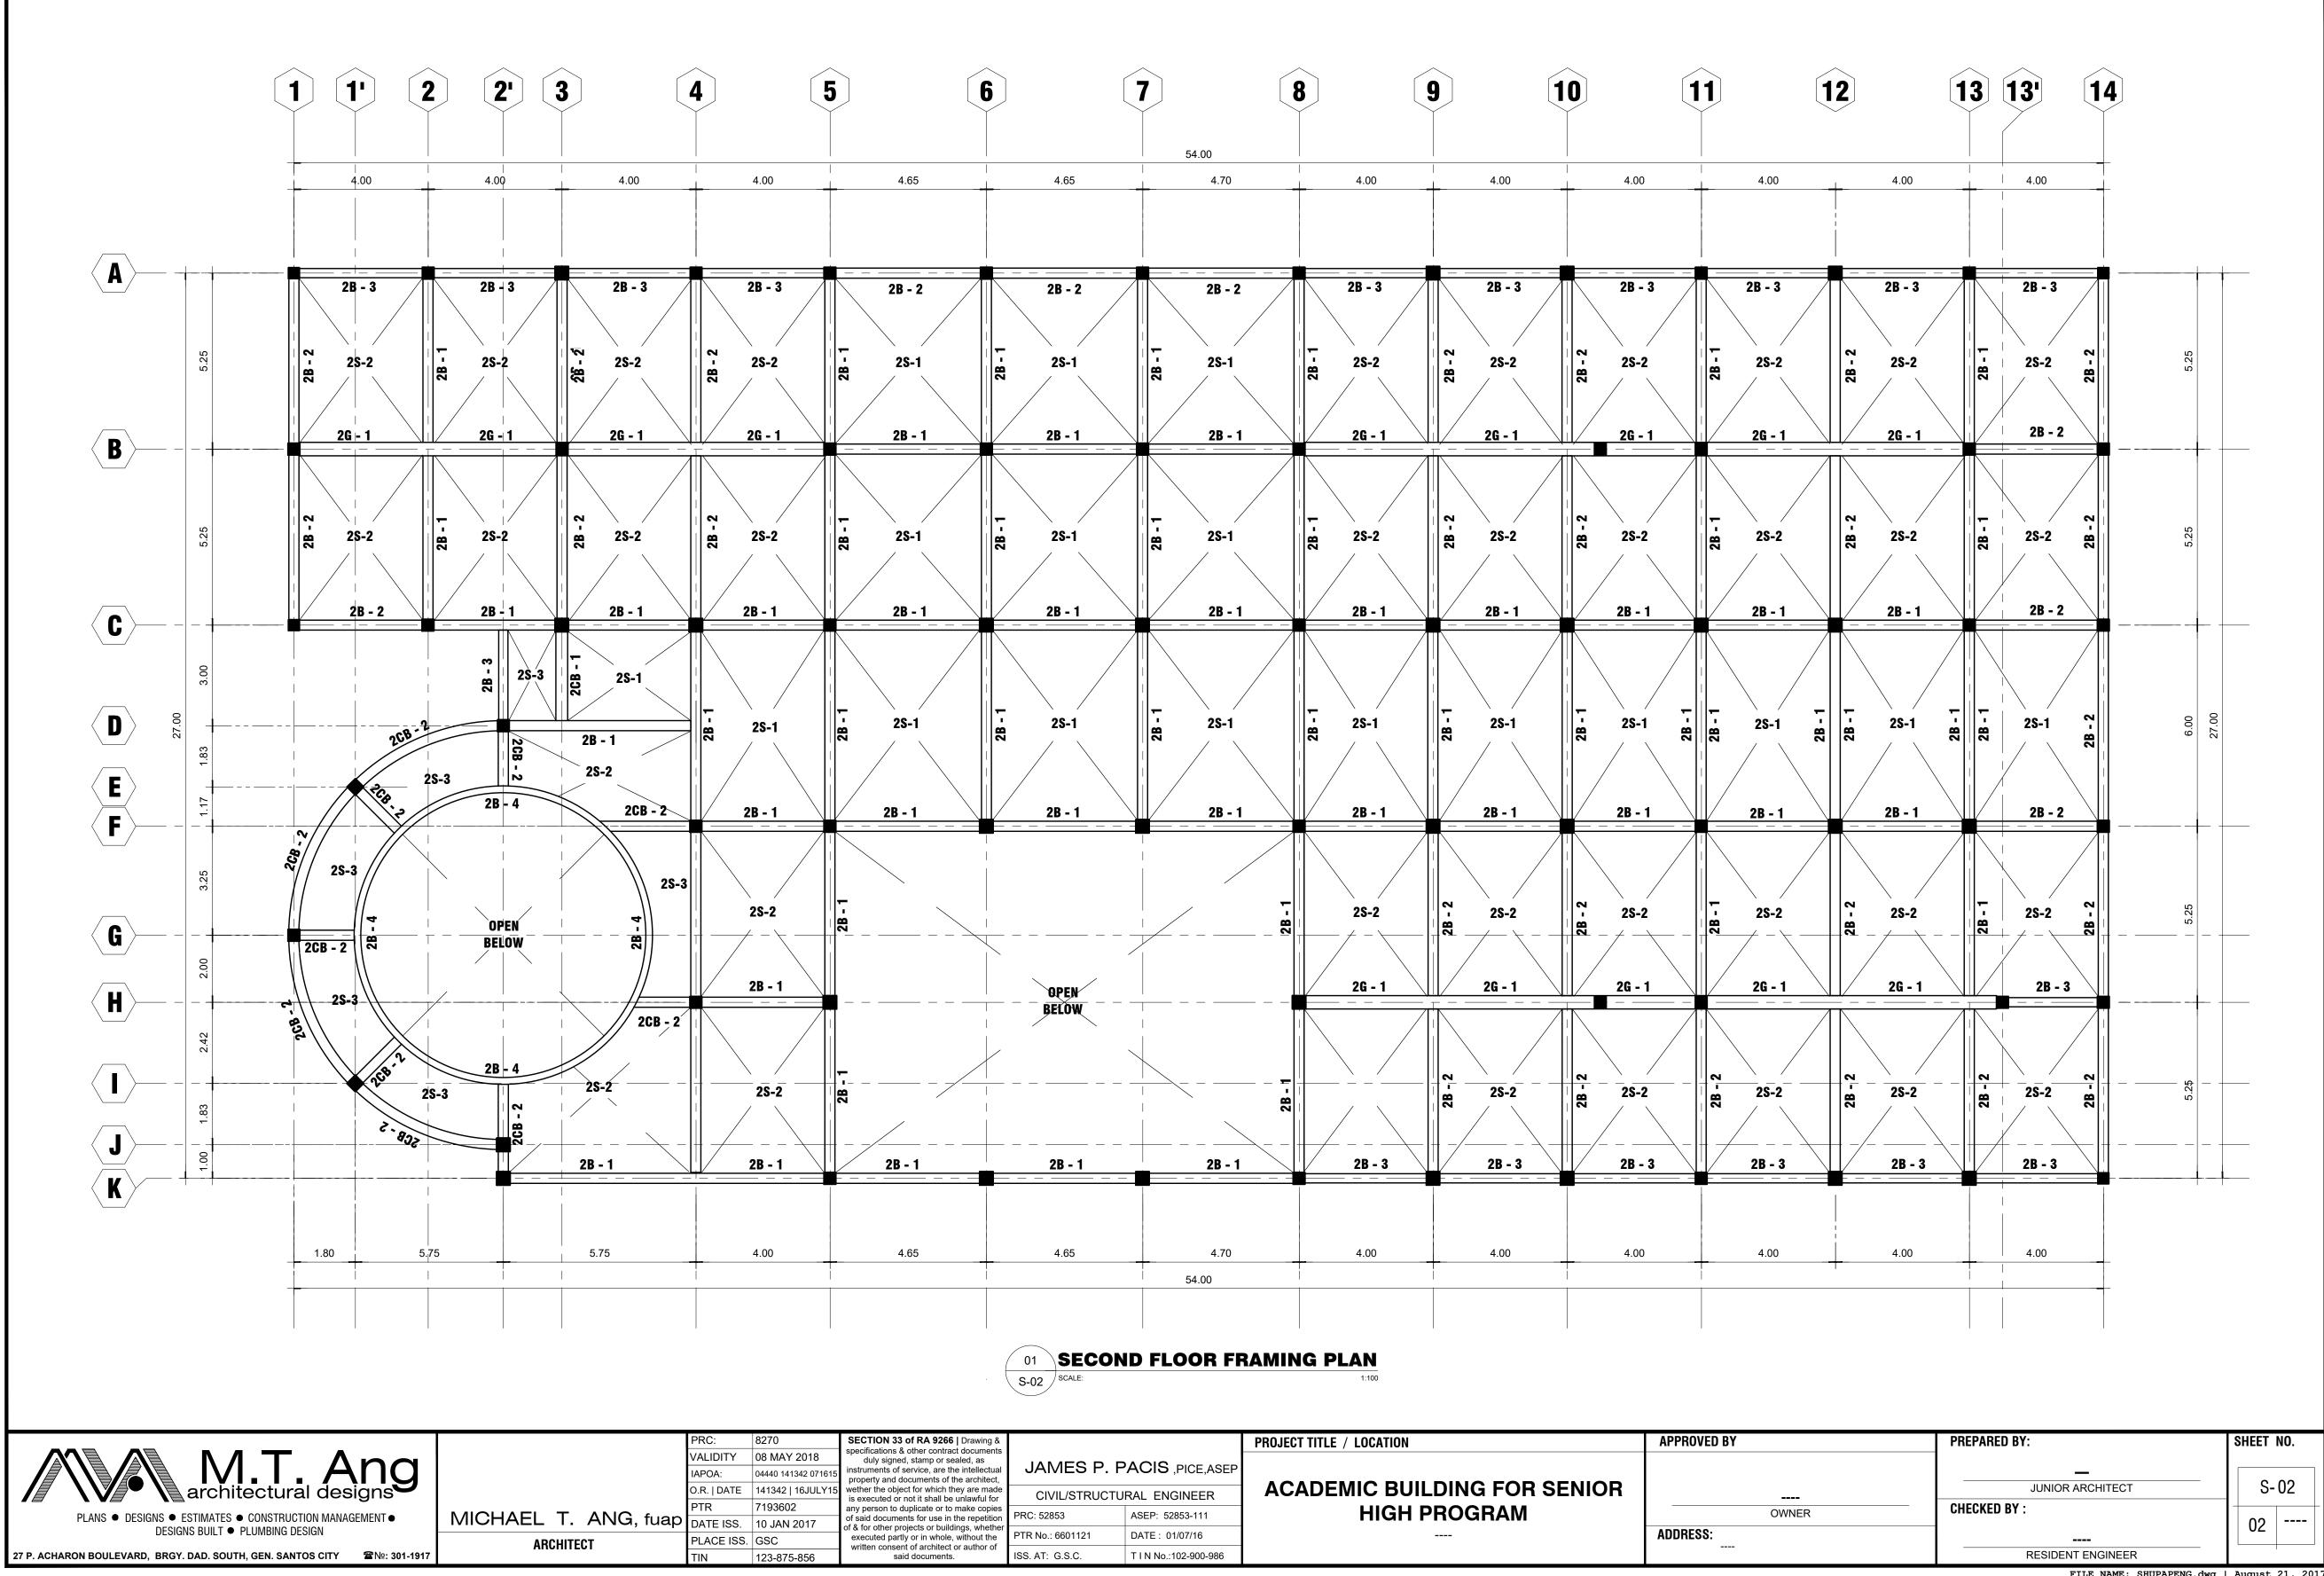


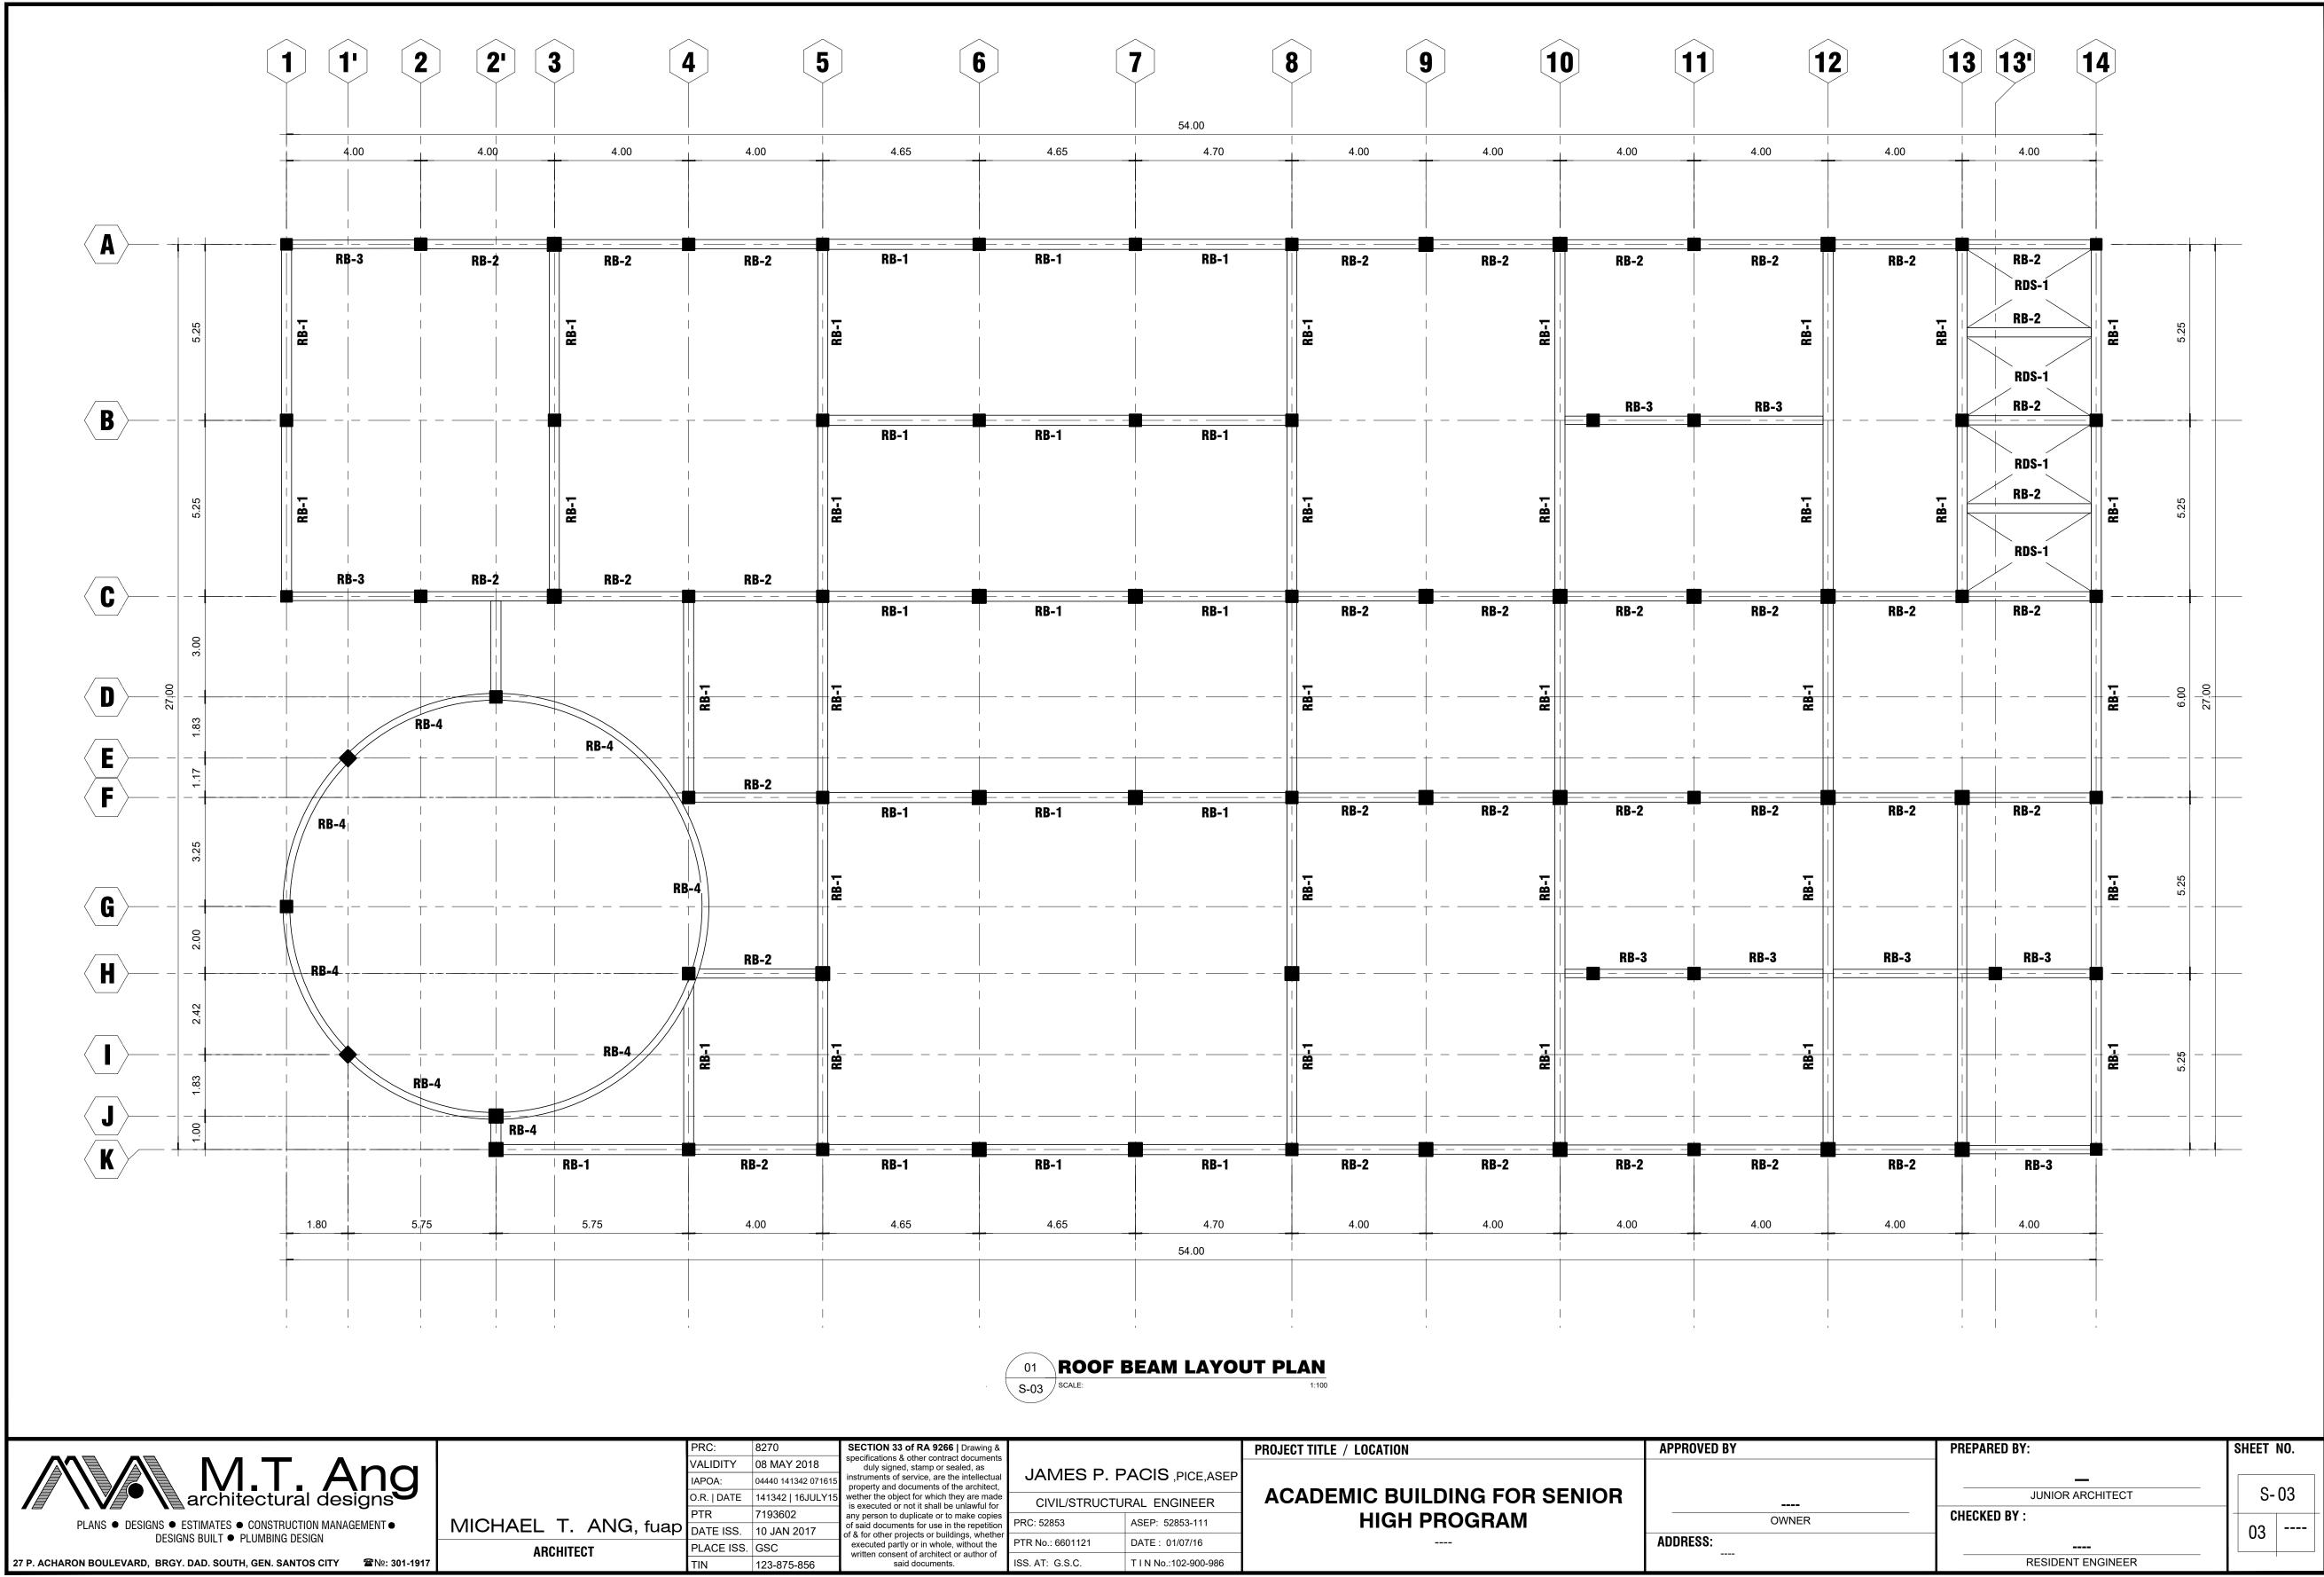


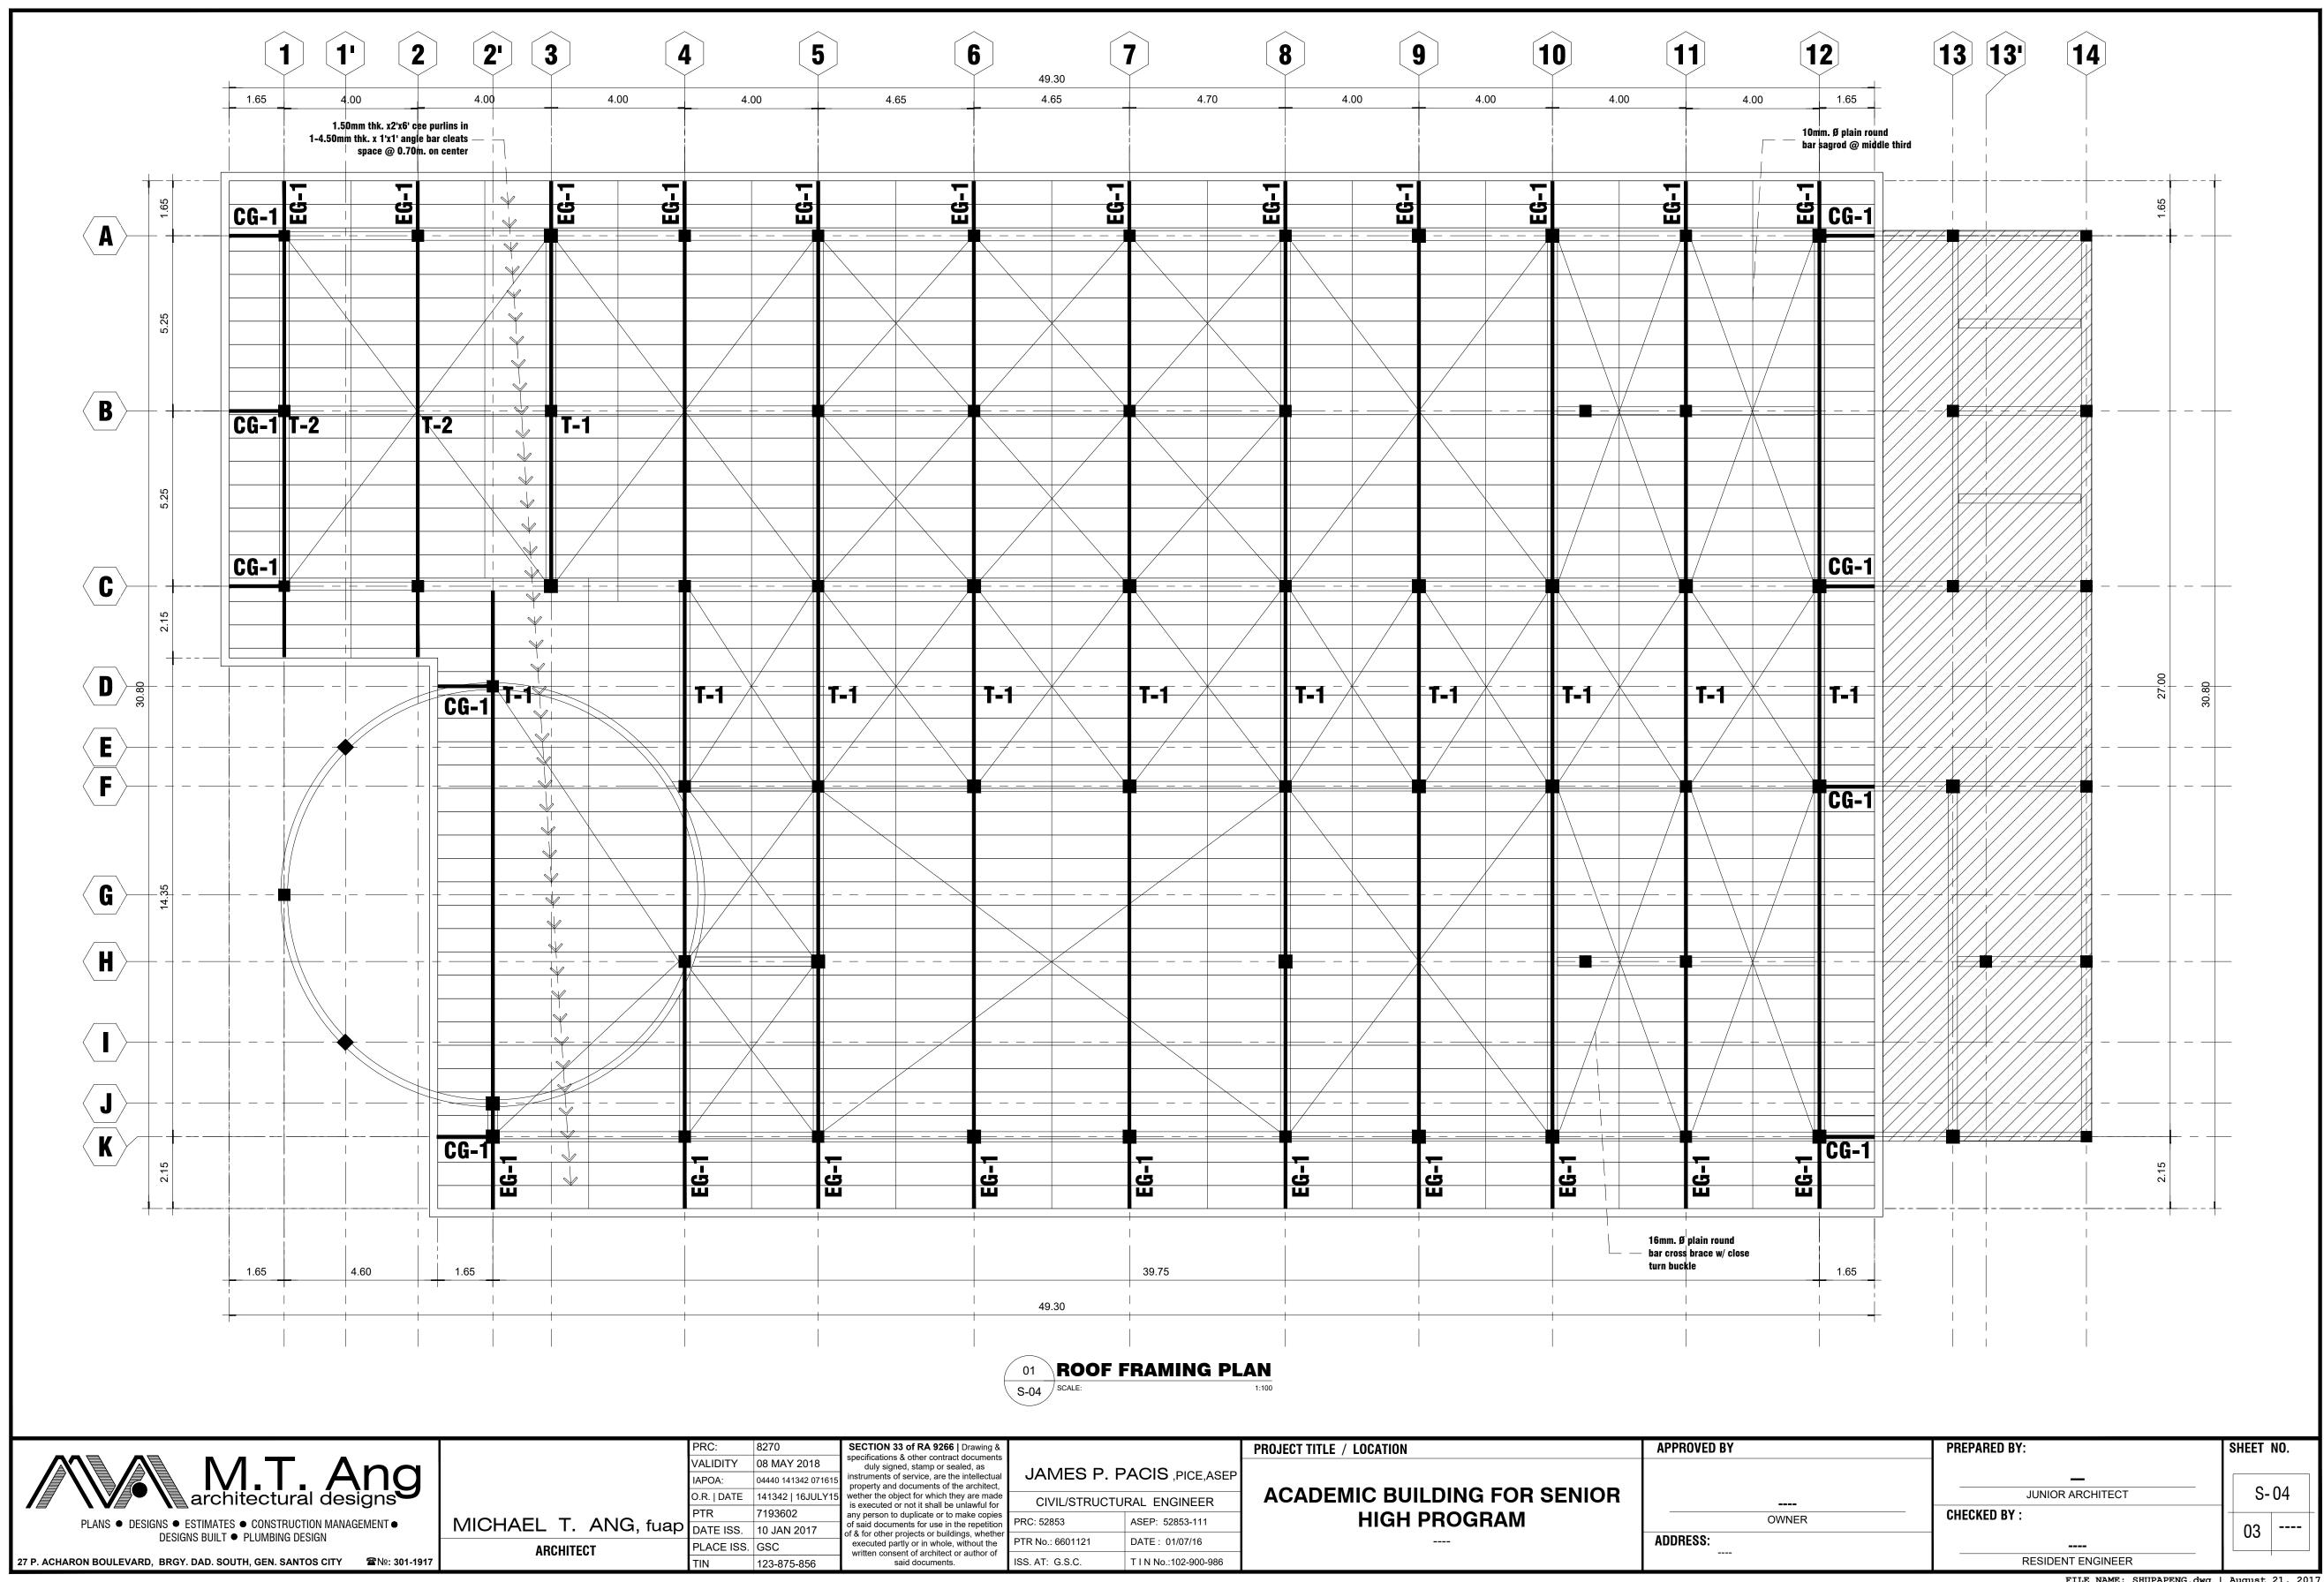


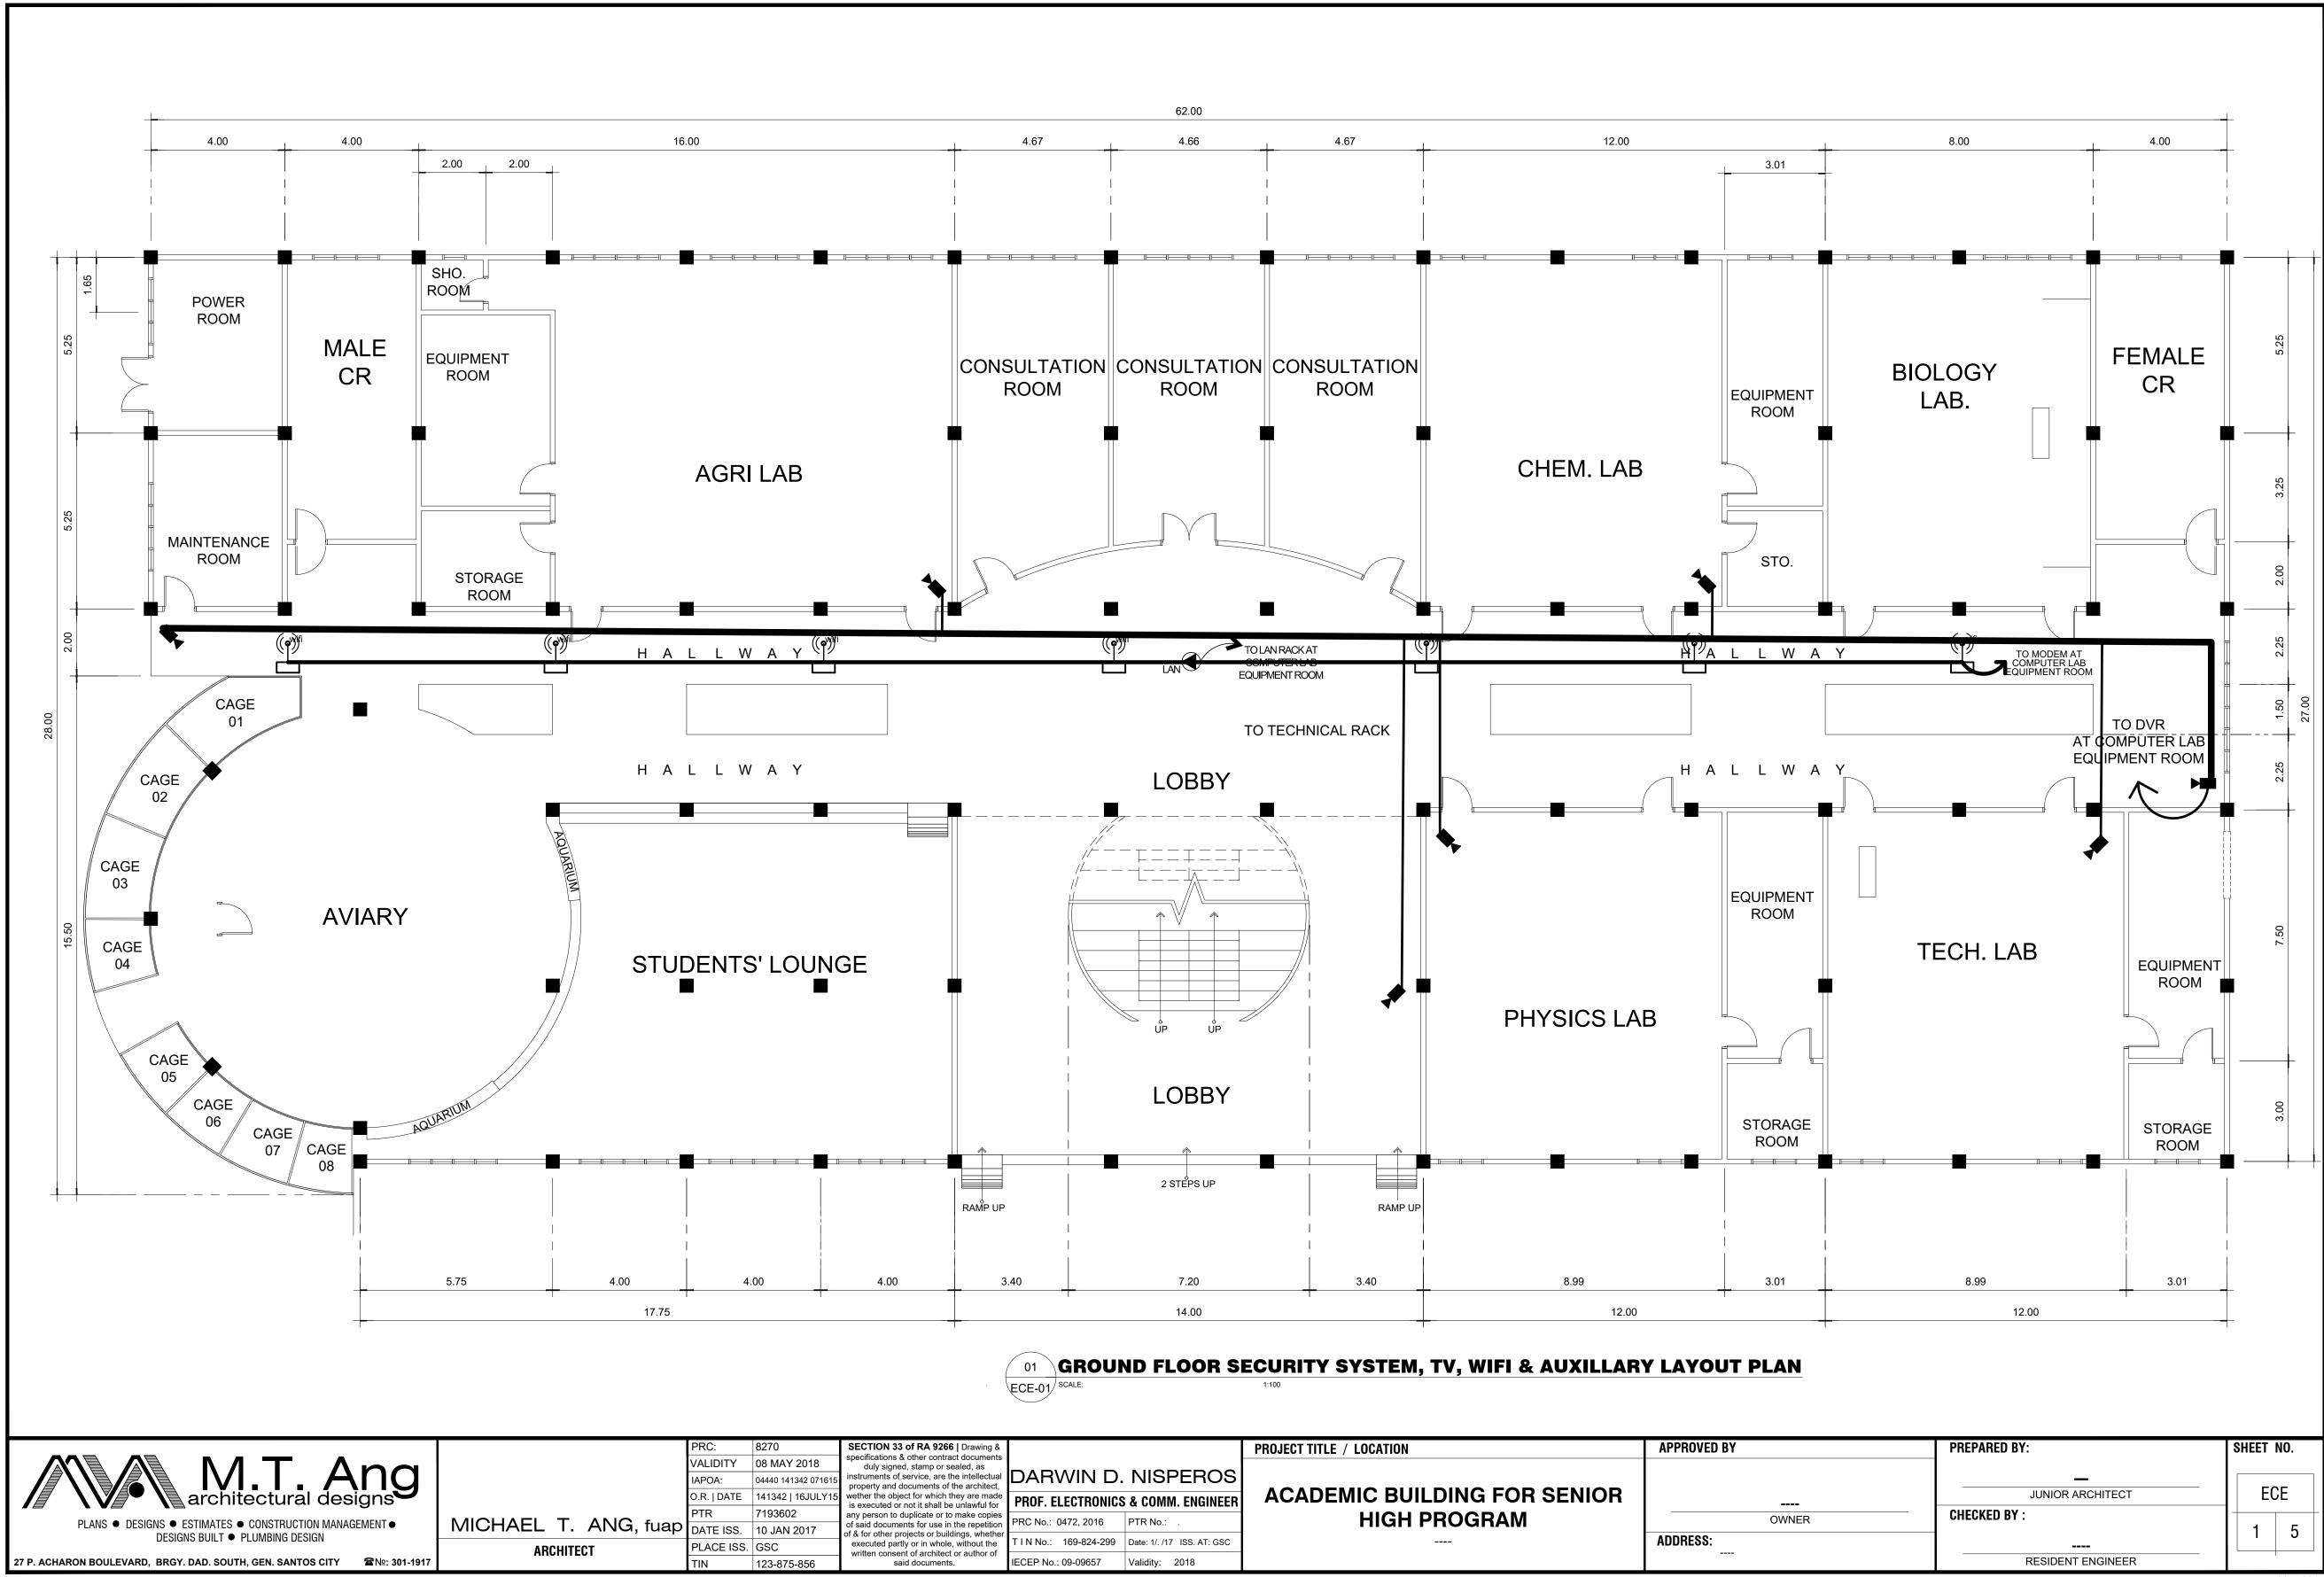


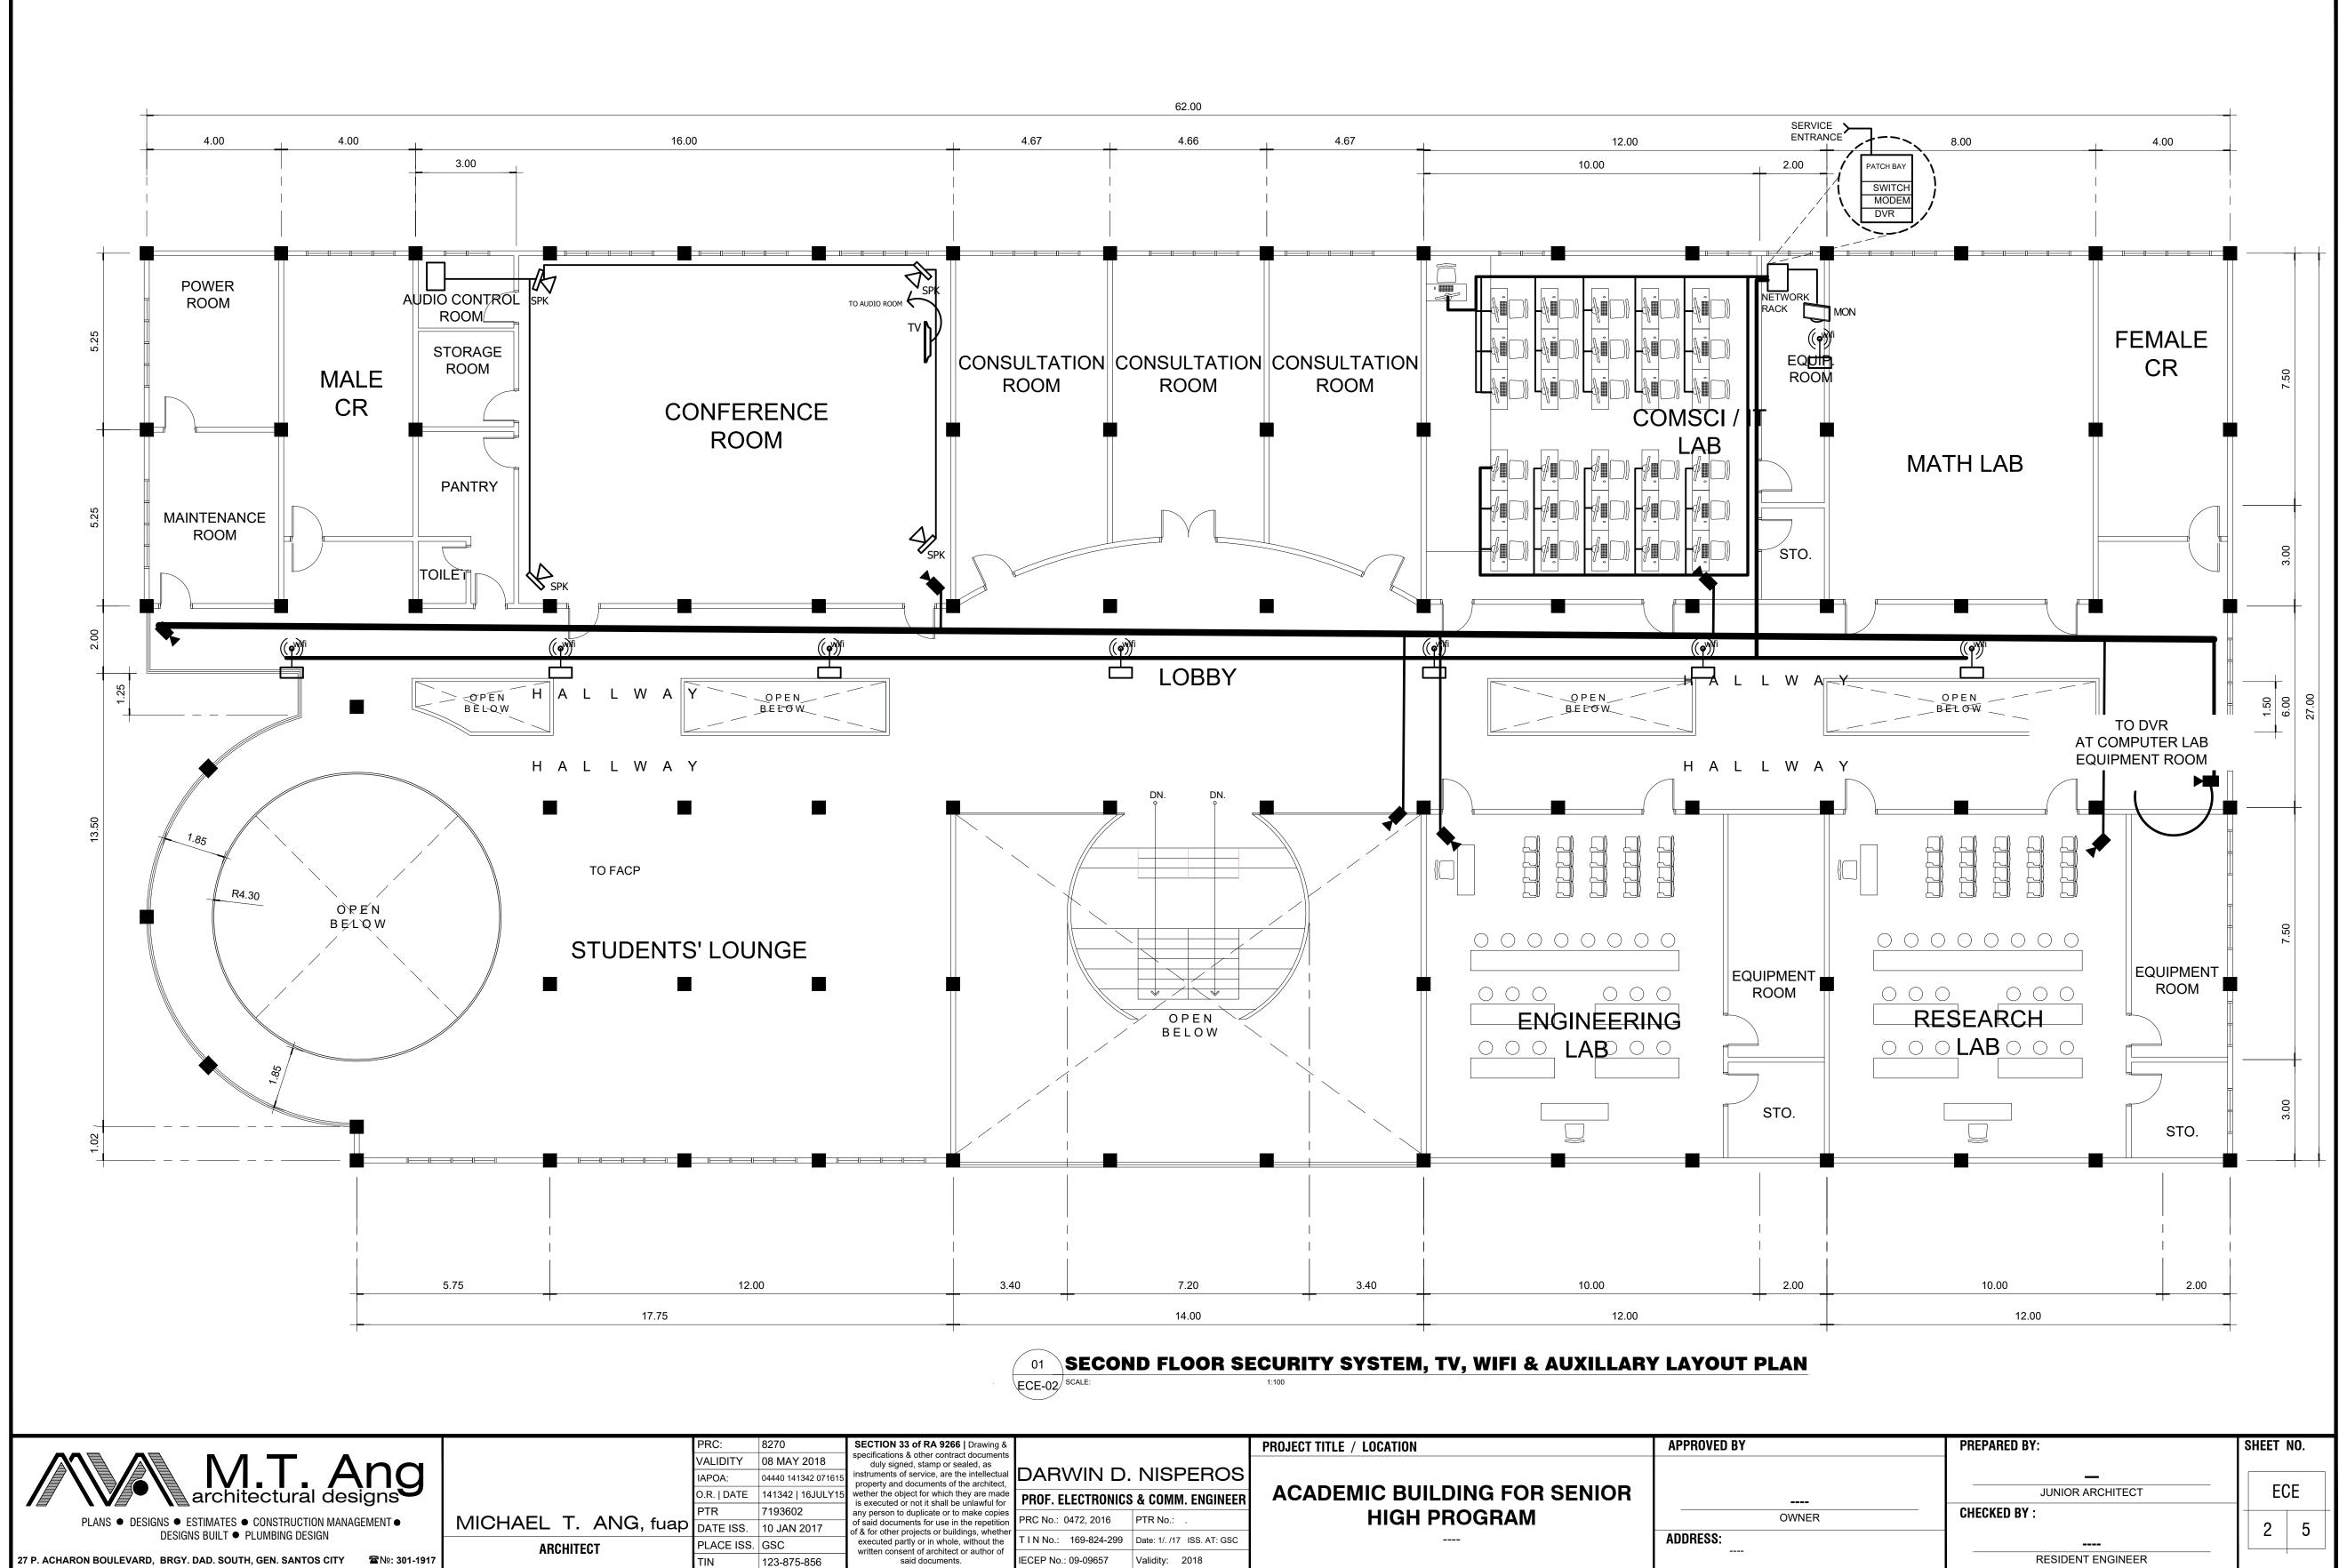


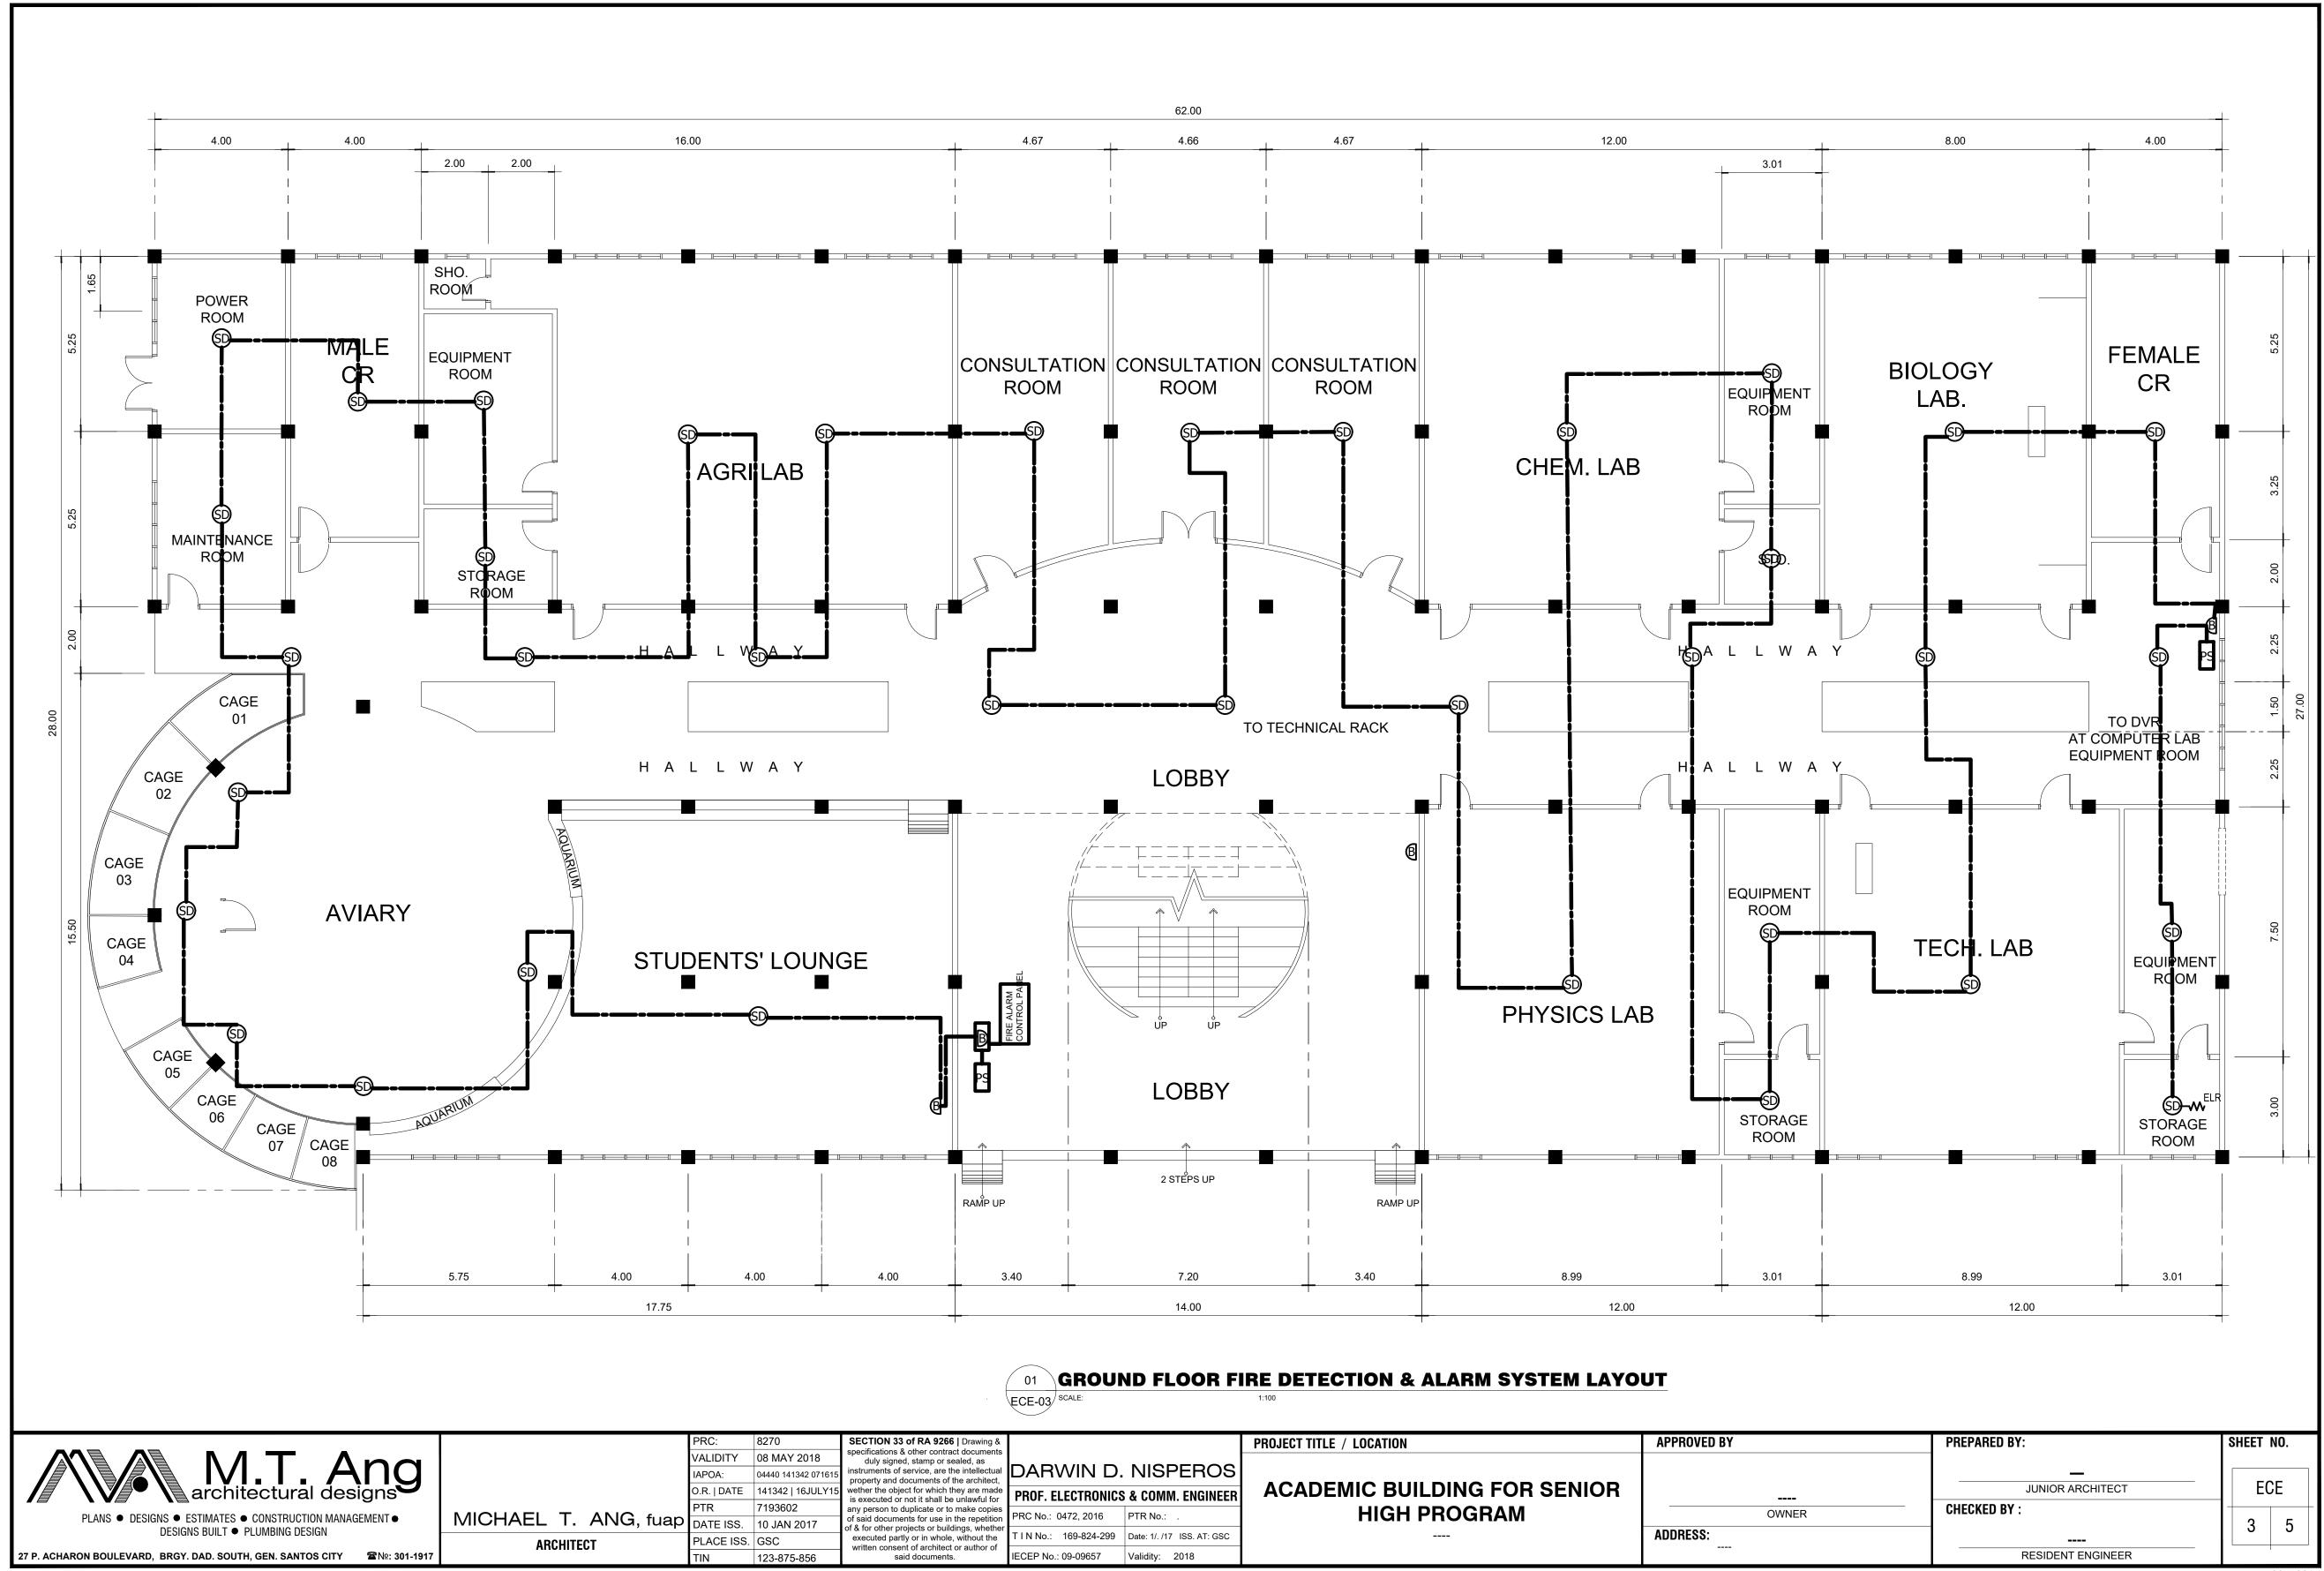

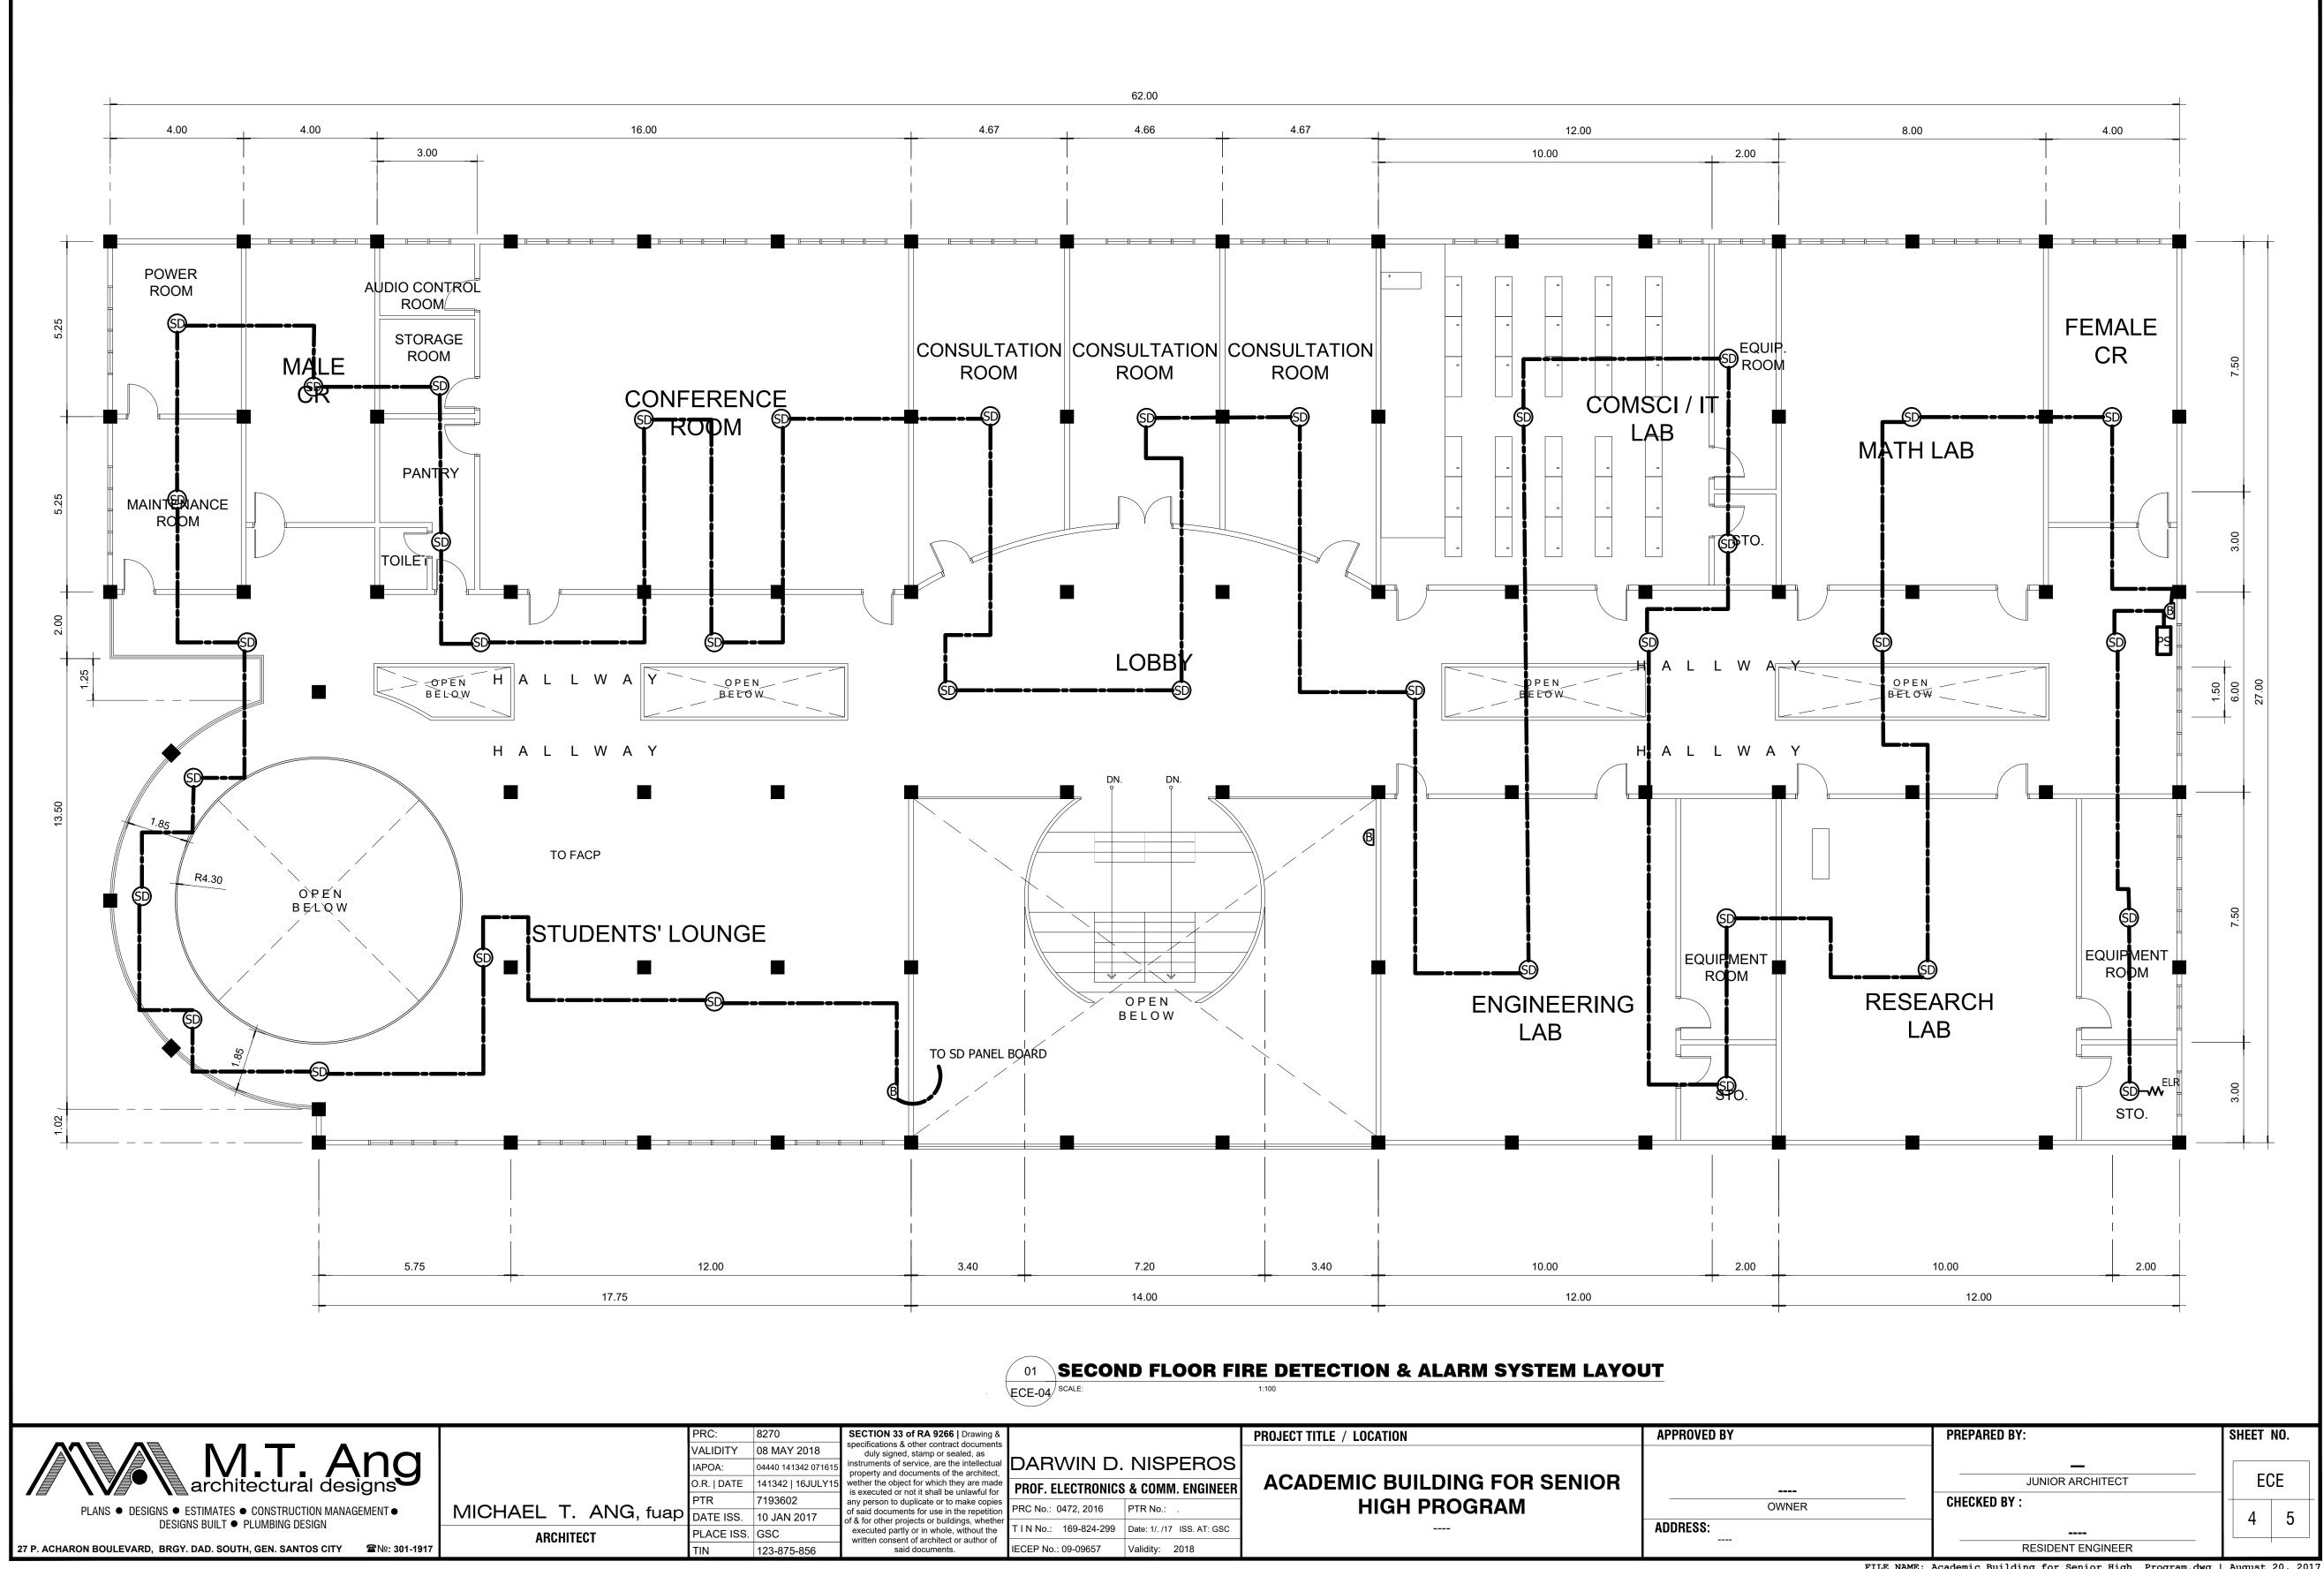

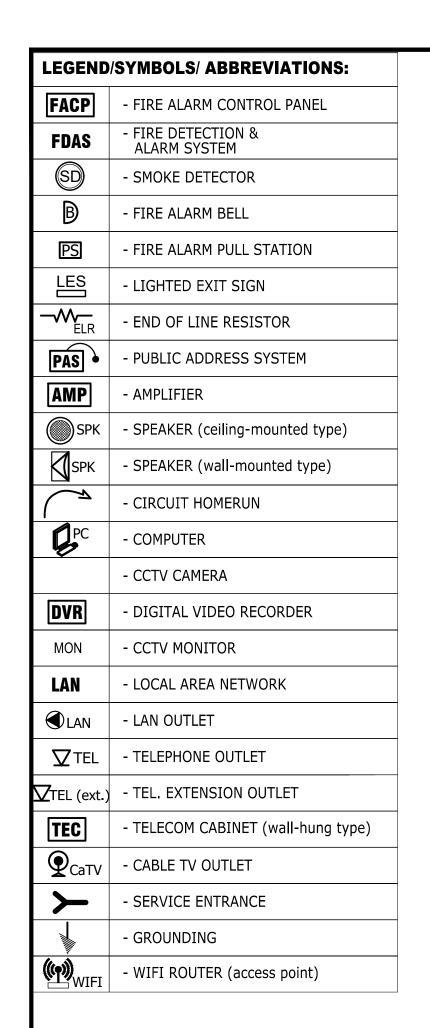

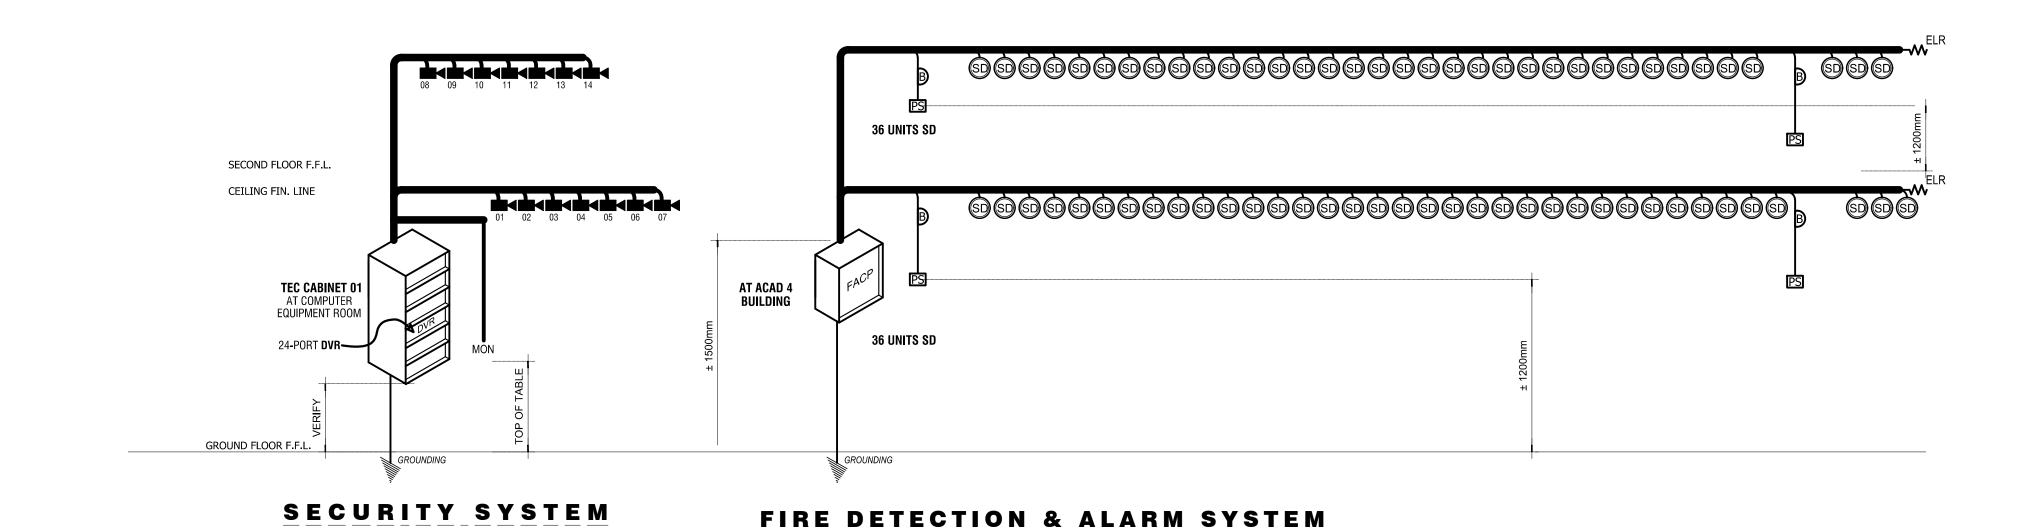

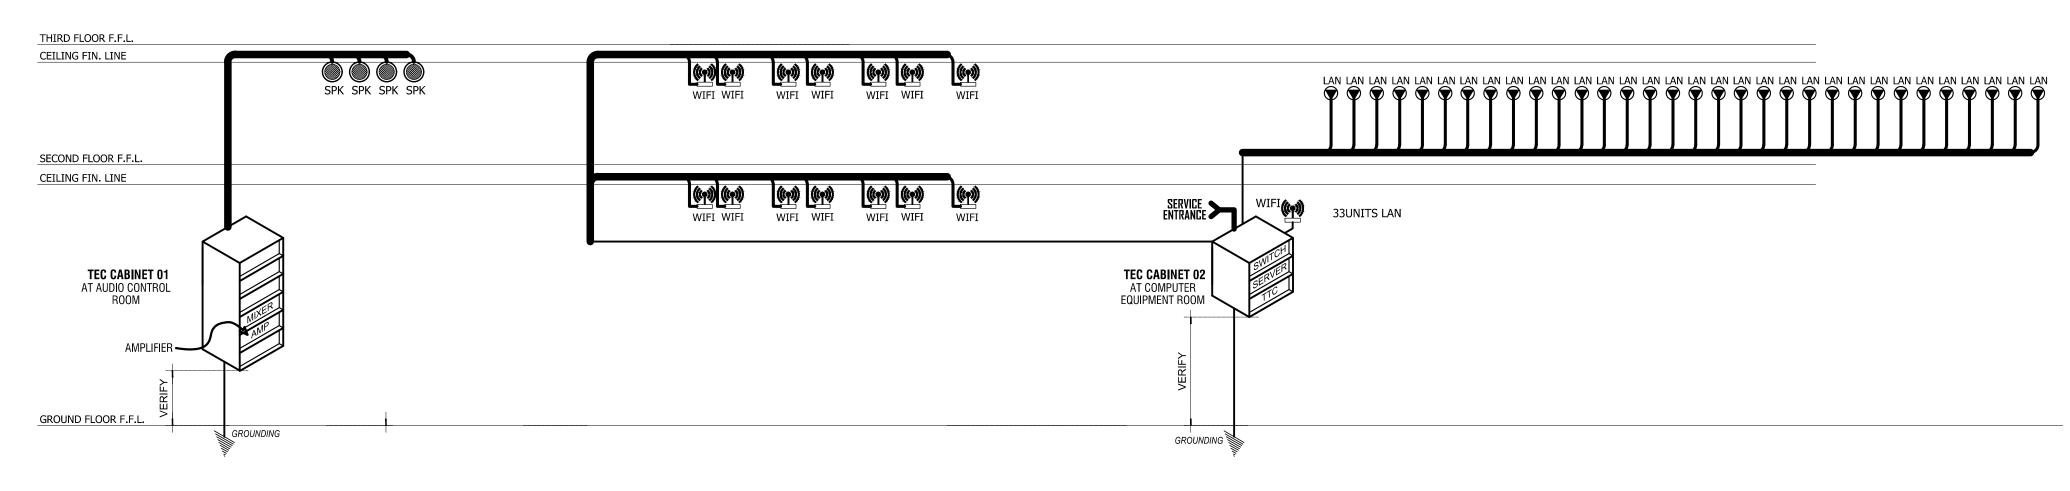

01 SINGLE LINE RISER DIAGRAM
ECE-05 SCALE: 1:100

AUDIO SPEAKER SYSTEM

WIFI SINGLE LINE DIAGRAM

LOCAL AREA NETWORK RISER DIAGRAM

ELECTRONIC NOTES:

- ALL ELECTRONIC WORKS HEREIN SHALL BE DONE IN ACCORDANCE WITH THE PROVISION OF THE LATEST EDITION OF THE PHIL. ELECTRONIC CODE, THE RULES AND REGULATIONS OF THE LOCAL ENFORCING AUTHORITIES AND THE REQUIREMENTS OF THE POWER COMPANY.
- ALL ELECTRONIC WORKS INCLUDED HEREIN SHALL BE EXECUTED BY ELECTRONIC TECHNICIAN UNDER THE DIRECT SUPERVISION OF A FULL-TIME LICENSED/PROF. ELECTRONIC AND COMMUNICATION ENGINEER. WORKS SHALL BE NEATLY PLACED, SECURELY FASTENED AND PROPERLY FINISHED.
- THE CONTRACTOR SHALL VERIFY AND ORIENT THE ACTUAL LOCATION OF SERVICE ENTRANCE FOR CONNECTION TO COMMUNICATION SUPPLY.
- ALL MATERIALS SHALL BE BRAND NEW AND SHALL CONFORM WITH THE PROVISIONS OF THE UNDERWRITERS LABORATORIES INC. IN EVERY CASE WHERE SUCH A STANDARD HAS BEEN ESTABLISHED.
- ALL CONDUITS MUST BE PROTECTED AGAINST DAMAGES BY THE ENTRANCE OF WATER AND FOREIGN MATTERS DURING CONSTRUCTION. ALL ENDS OF CONDUITS SHALL BE PLUGGED TO EXCLUDE MOISTURE AND DUST IMMEDIATELY AFTER THE CONDUITS ARE PLACED.
- UNLESS OTHERWISE SPECIFIED, ALL ELECTRONIC WIRING INSTALLATION SHALL BE USED RSC PIPE. THE MINIMUM SIZE OF CONDUIT SHALL BE 15mm Ø.
- ALL OUTLET BOXES SHALL BE GALVANIZED GA. 16, DEEP-TYPE WITH FACTORY KNOCKOUTS. PULLBOXES SHALL BE USED WHEN APPLICABLE FOR EASY PULLING OF WIRES AND SHALL BE IN ACCORDANCE WITH THE PHILIPPINE ELECTRONIC CODE REQUIREMENTS. PREFERRED BRAND FOR JUNCTION, PULLBOX OR UTILITY SQUARE BOXES SHALL BE FUMACO, AMCU, TIMCO, OR APPROVED EQUAL.
- MOUNTING HEIGHTS OF DEVICES SHALL BE: (SUBJECT TO ARCHITECT'S APPROVAL PRIOR TO INSTALLATION), DATA OUTLET SHALL BE 0.30m ABOVE FINISHED FLOOR TO CENTER OF DEVICE.
- THE PLANS AS DRAWN ARE BASED UPON THE ARCHITECTURAL PLANS AND THE DETAILS AND SHOWN CONDITION AS ACCURATELY AS IT IS POSSIBLE TO INDICATE THEM IN SCALE, THE PLANS ARE DIAGRAMMATICAL AND DOES NOT NECESSARY SHOW ALL FITTINGS NECESSARY TO FIT TO THE BUILDING CONDITIONS. THE LOCATIONS OF OUTLETS, APPARATUS AND APPLIANCES SHOWN ON THE PLANS ARE APPROXIMATE. THE CONTRACTOR SHALL BE HELD RESPONSIBLE FOR THEIR PROPER LOCATION IN ORDER TO MAKE THEM FIT WITH THE ARCHITECTURAL DETAILS AND INSTRUCTIONS FROM THE ENGINEER'S REPRESENTATIVE AT THE SITE.

GENERAL SPECIFICATIONS:

- 1. THIS DRAWING IS SCHEMATIC REPRESENTATION OF SYSTEM ONLY. TENDERS TO DETAIL COMPLIANT OFFER BASED ON MANUFACTURER'S SYSTEM AND WIRING METHODS RECOMMENDATION.
- 2. SMOKE DETECTOR SHALL BE INTERFACED TO FIRE ALARM SYSTEM.
- 3. WIRING INSTALLATION (CEILING CONCEALED, EMBEDDED, EXPOSED OR SURFACED) SHALL BE USED RSC OR EMT, 15mm Ø MINIMUM.
- 4. WIRING METHODS SHALL BE AS FOLLOWS:
 - A. SMOKE DETECTOR 1.25 m² TF WIRE
 B. CONTROL/ZONE MODULE 2.0 mm² UTP WIRE
 - C. TEL/LAN CABLE #24 AWG 4 PAIRS UTP CABLE/CAT5-E/CAT6
 D. CCTV CABLE RG-59/6 COAX CABLE
- 5. CONDUIT SHALL BE PERMANENTLY AND EFFECTIVELY GROUNDED.
- 6. THIS ARRANGEMENT IS LIMITED TO DROP WIRE ATTACHMENT OF UP TO 5 LINES.
- 7. SPAN TO FIXTURE SHALL BE NOT EXCEED 45.7m.
- 8. SERVICE SHALL BE SUFFICIENTLY HIGH TO PROVIDE PROPER DROP WIRE CLEARANCE OVER SIDE, STREETS OR ROADWAYS IN COMPLIANCE WITH THE CODES AND REGULATIONS.

